

PLANNING BOARD RE-SUBMISSION 10-13-2022

LOCUS PLAN PROJECT SITE

PROJECT: McGrath Residences

PROJECT ADDRESS: 394 McGRATH HIGHWAY SOMERVILLE, MA

<u>ARCHITECT</u> KHALSA DESIGN INC.

17 IVALOO STREET, SUITE 400 SOMERVILLE, MA 02143 T:(617) 591-8682 www.tkgeast.com

<u>CIVIL</u> PETER NOLAN & ASSOCIATES LLC 697 CAMBRIDGE STREET, SUITE 103 BRIGHTON, MA 02135 T:(857) 891-7478

4-Photometric

Photometric Plan Photometric Plan

CONTEMPO BUILDERS 100 TRADECENTER, SUITE G-700 WOBURN, MA 01801 T:(617) 610-0880

T:(617) 735-1180

CLIENT

LANDSCAPE ARCHITECT **VERDANT** 318 HARVARD ST, SUITE 25 BROOKLINE, MA 02446

Drawing List Sheet Issue Sheet Number **Sheet Name** Date 0-Cover A-000 09/23/22 Cover Sheet 1-Civil C-001 Existing Conditions Site Plan 3/12/2020 C-002 Proposed Civil Site Plan 3/12/2020 C-003 Civil Details 3/12/2020 C-004 3/12/2020 Civil Details 2-Landscape Landscape Plan 3/12/2020 L-2 Landscape Plan 3/12/2020 L-3 Green Score Calculations 3/12/2020 3-Architectural A-018 09/23/22 **Gross Area Plans** A-019 09/23/22 Unit Area Plans Architectural Site Plan 09/23/22 A-100 1st Floor Plan 09/23/22 A-101 09/23/22 2nd Floor Plan A-102 09/23/22 3rd Floor Plan A-103 09/23/22 4th Floor Plan A-105 09/23/22 Roof Plan A-300 **Exterior Elevations** 09/23/22 A-301 Exterior Perspectives 09/23/22 AV-1 09/23/22 Street View AV-2 09/23/22 Shadow Study

03/12/20

03/12/20

PROJECT NAME **McGrath** Residences

PROJECT ADDRESS

394 McGrath Highway Somerville, MA

CLIENT

Mike Tokatlyan

ARCHITECT

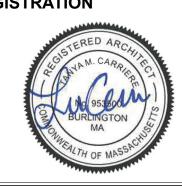


17 IVALOO STREET SUITE 400

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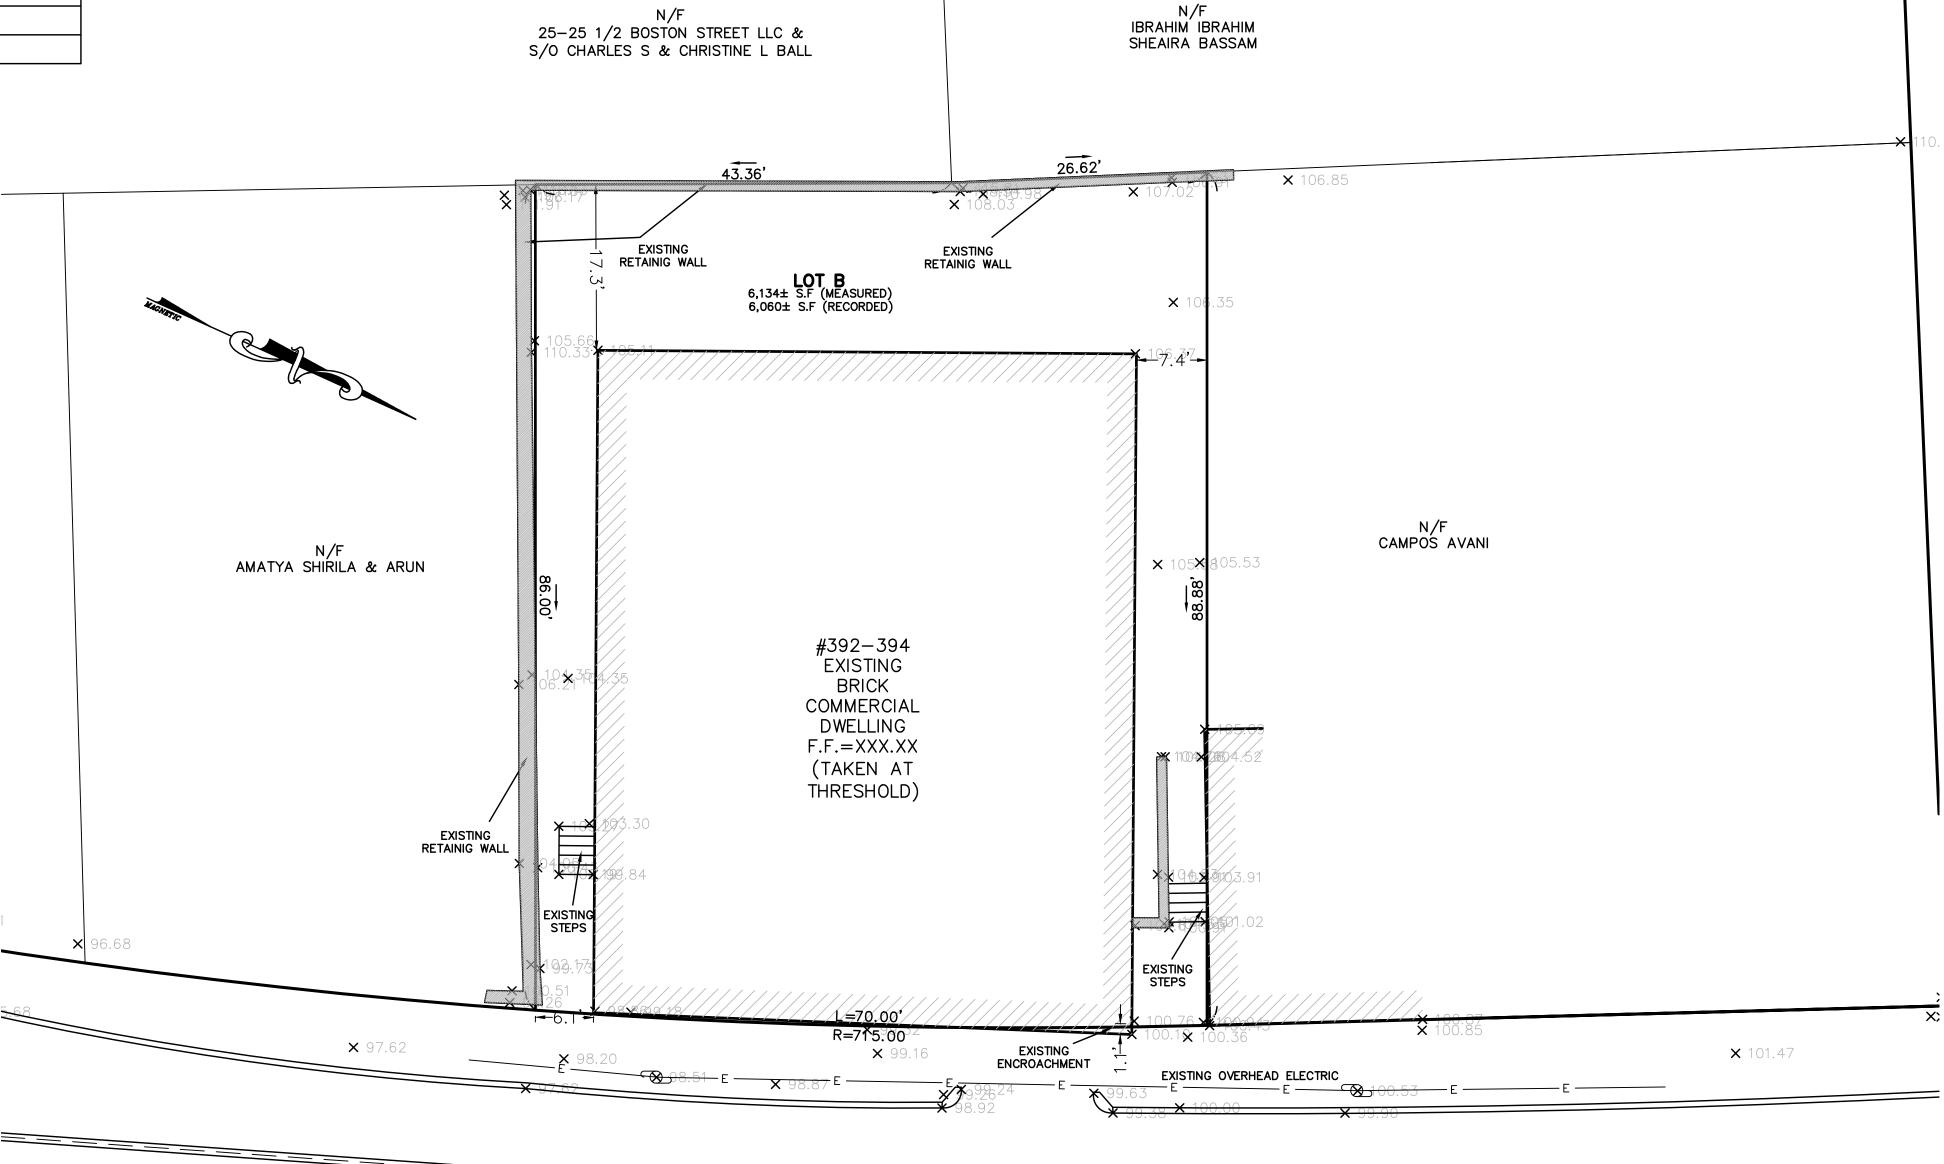
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No.	Description	Date

Cover Sheet

EXIST	ING LEGEND
	TREE
-0-	SIGN
S	SEWER MANHOLE
₩ ⊠	WATER VALVE
G _V ⊠	GAS VALVE
Q	UTILITY POLE
M	MANHOLE
× 37.00	SPOT GRADE
	EXISTING BUILDING
<u> </u>	FENCE
	SEWER LINE
w	WATER LINE
——— OHW ———	OVERHEAD WIRES
35	CONTOUR LINE (MJR)
37	CONTOUR LINE (MNR)



MCGRATH HIGHWAY (PUBLIC WAY-VARIABLE WIDTH)

NOTES:

1. INFORMATION SHOWN ON THIS PLAN IS THE RESULT OF A FIELD SURVEY PERFORMED BY PETER NOLAN & ASSOCIATES LLC AS OF 3/26/2019.

2. DEED REFERENCE: BOOK 30670, PAGE 390
PLAN REFERENCE: END OF BOOK 2938
MIDDLESEX COUNTY SOUTH DISTRICT REGISTRY OF DEEDS.

3. THIS PLAN IS NOT INTENDED TO BE RECORDED.

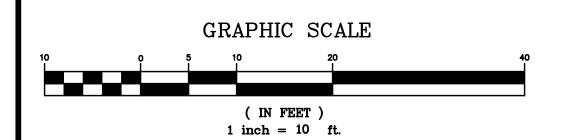
4. I CERTIFY THAT THE DWELLING SHOWN IS NOT LOCATED WITHIN A SPECIAL FLOOD HAZARD ZONE. IT IS LOCATED IN ZONE X, ON FLOOD HAZARD BOUNDARY MAP NUMBER 25017C0439E, IN COMMUNITY NUMBER: 250214, DATED 6/4/2010.

5. THIS PLAN DOES NOT SHOW ANY UNRECORDED OR UNWRITTEN EASEMENTS WHICH MAY EXIST. A REASONABLE AND DILIGENT ATTEMPT HAS BEEN MADE TO OBSERVE ANY APPARENT USES OF THE LAND; HOWEVER THIS NOT CONSTITUTE A GUARANTEE THAT NO SUCH EASEMENTS EXIST.

6. FIRST FLOOR ELEVATIONS ARE TAKEN AT THRESHOLD.

7. NO RESPONSIBILITY IS TAKEN FOR ZONING TABLE AS PETER NOLAN & ASSOCIATES LLC ARE NOT ZONING EXPERTS. TABLE IS TAKEN FROM TABLE PROVIDED BY LOCAL ZONING ORDINANCE. CLIENT AND/OR ARCHITECT TO VERIFY THE ACCURACY OF ZONING ANALYSIS.

ALE 10'					
TE /2019	REV	DATE	REVISION	BY	
EET			394 MCGRATH HIGHWAY SOMERVILLE		
AN NO. F 1			MASSACHUSETTS		
ENT:			EXISTING		SHEET NO.
AWN BY			CONDITIONS		
KD BY			TER NOLAN & ASSOCIATES LL ND SURVEYORS/CIVIL ENGINEERING CONSULTANT 607 CAMPRIDGE STREET SUITE 107 PRICUTON NA 02135		
PD BY		PHONE EM	697 CAMBRIDGE STREET, SUITE 103 BRIGHTON MA 02135 :: 857 891 7478/617 782 1533 FAX: 617 202 56 AIL: pnolan@pnasurveyors.cor	91 m	



TREE SIGN 0 SEWER MANHOLE S WATER VALVE $\ddot{\bowtie}$ GAS VALVE Q UTILITY POLE M MANHOLE **X** 37.00 SPOT GRADE EXISTING BUILDING FENCE \multimap SEWER LINE WATER LINE — он w —— OVERHEAD WIRES N/F IBRAHIM IBRAHIM ___35___ | CONTOUR LINE (MJR) 25-25 1/2 BOSTON STREET LLC & SHEAIRA BASSAM S/O CHARLES S & CHRISTINE L BALL CONTOUR LINE (MNR) 43.36 **×** 106.85 LOT B 6,134± S.F (MEASURED) OUTLINE OF 6,060± S.F||(RECORDED) **FLOOR** PARKING PARKING AIPARKING SPACE #2 SPACE #4 PARKING PARKING SPACE #6 **ABOVE** OUTLINE OF FLOOR **ABOVE PROPOSED** PAVED DRIVEWAY N/F CAMPOS AVANI N/F AMATYA SHIRILA & ARUN DWELLING #392-394 PROPOSED PROPOSED MULTI-FAMILY RESIDENTIAL PROPOSED PAVED DRIVEWAY EXISTING RETAINIG WALL **DWELLING ×** 101.47 EXISTING OVERHEAD ELECTRIC APPROX. LOCATION OF 12" WATER MAIN (V.I.F.) PROPOSED CURB CUT PER CITY OF SOMERVILLE SPECIFICATIONS APPROX. LOCATION OF COMBINED SEWER (V.I.F.) EXISTING CURB CUT TO BE REMOVED AND SIDEWALK RESTORED MCGRATH HIGHWAY (PUBLIC WAY-VARIABLE WIDTH)

NOTES:

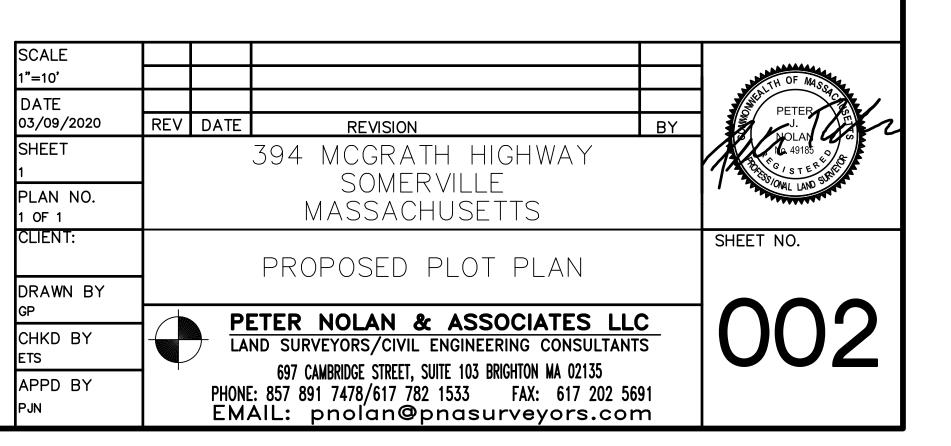
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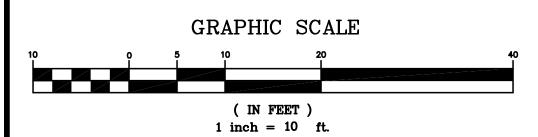
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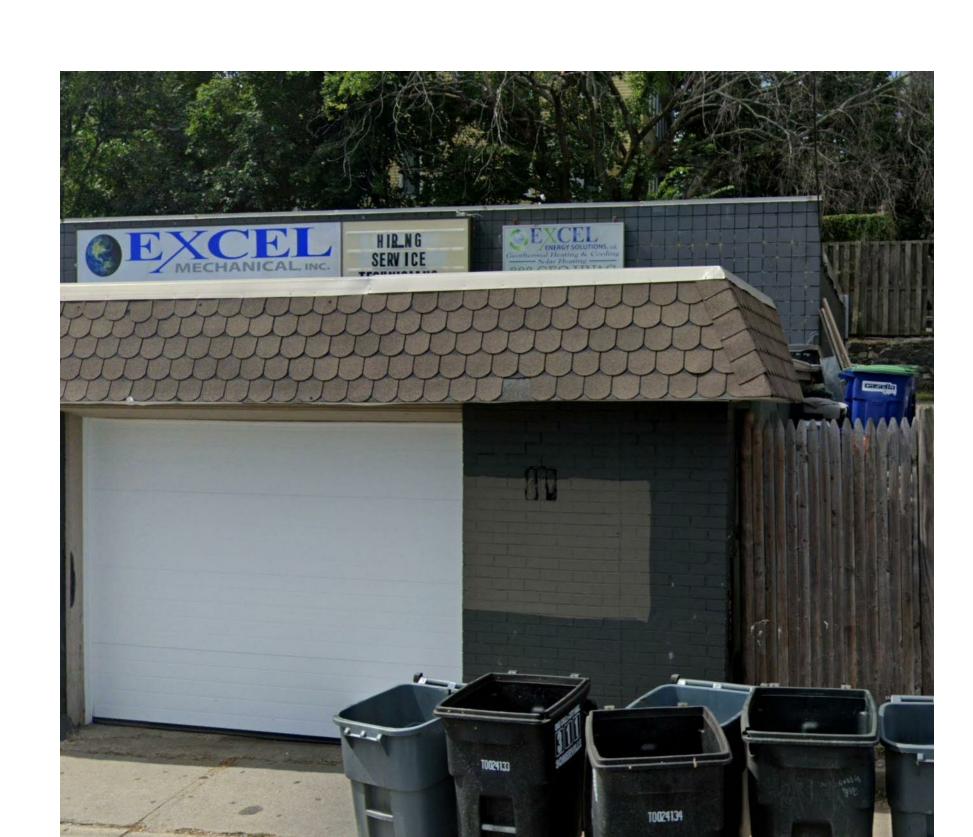
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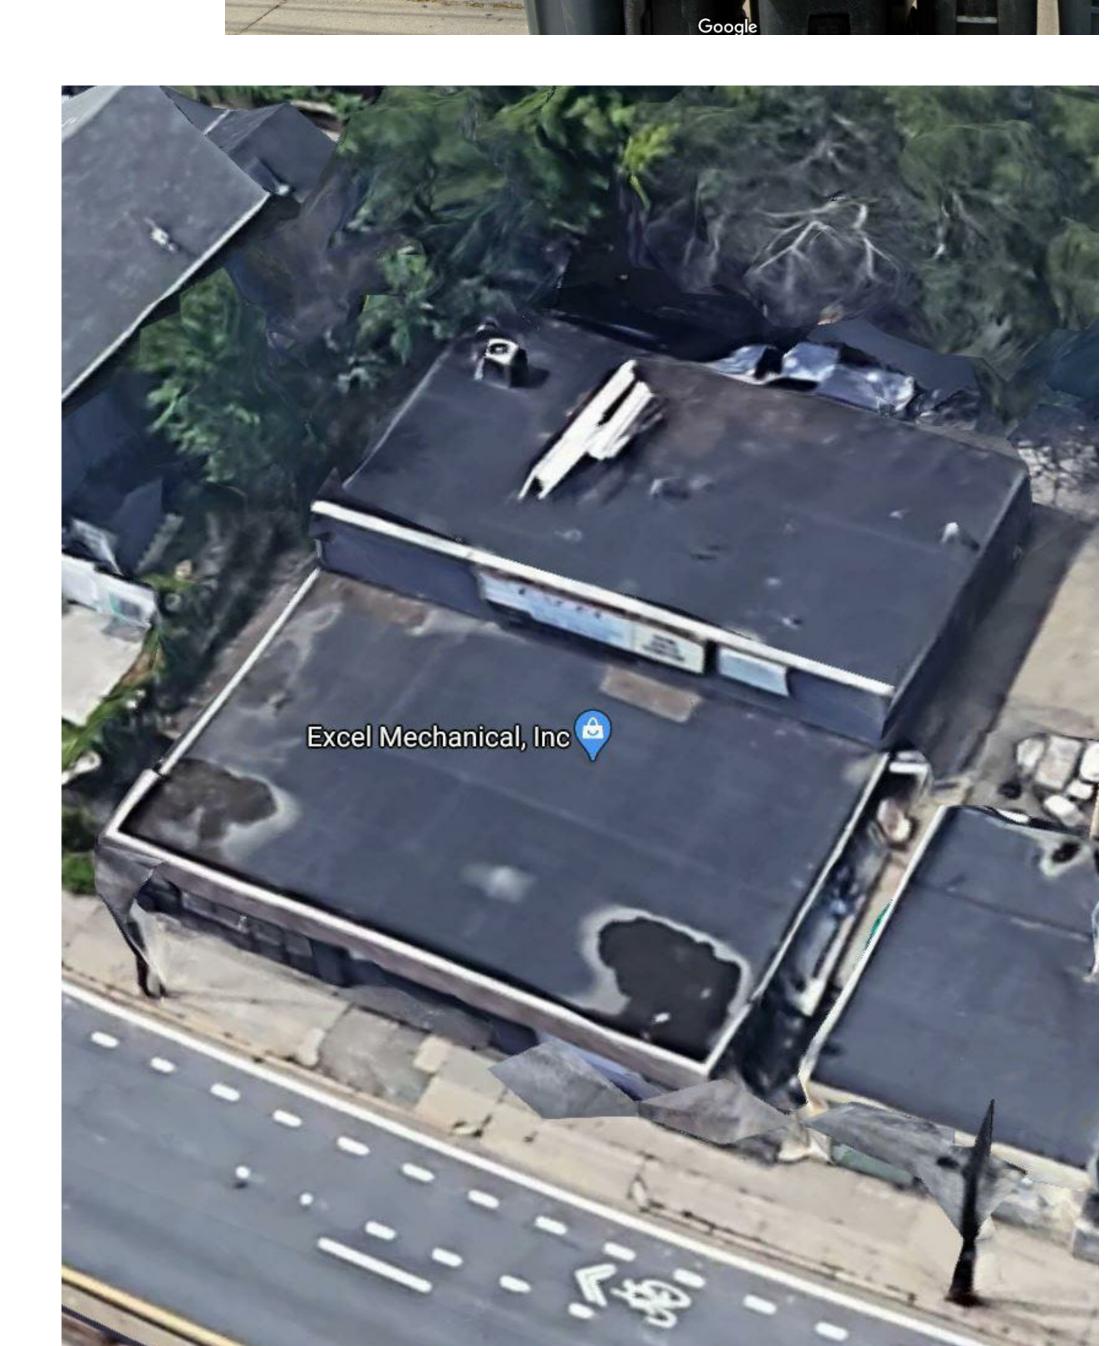
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EXISTING LEGEND









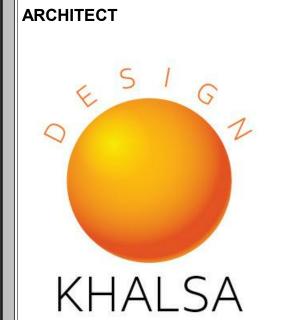
McGrath Residences

PROJECT ADDRESS

394 McGrath Highway Somerville, MA

CLIENT

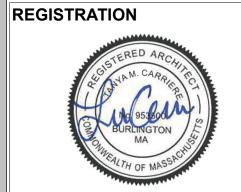
Mike Tokatlyan



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Existing Conditions

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Residences

McGrath

PROJECT ADDRESS 394 McGrath Highway Somerville, MA

CLIENT

PROJECT NAME

Mike Tokatlyan

ARCHITECT



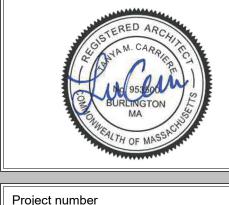
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Gross Area Plans

A-018 McGrath Residences



12/01/21 Author Checker 1/8" = 1'-0"



VISITOR BIKE RACK -

LINE OF BUILDING ABOVE

EXISTING RETAINING WALL

1 SITE PLAN 1/8" = 1'-0"

UNIT BREAKDOWN

KEY

SPACE

PAVED

AREA

USEABLE OPEN

PROPOSED

PROPOERTY

BUILDING **FOOTPRINT**

1-BEDROOM UNITS 2-BEDROOM UNITS

UNITS TOTAL

MCGRATH HIGHWAY

NEW STREET TREES (3)

TO E
SP
DB
HE

MCGRATH HIGHWAY

		MCGRA
	— EXISTING TREE TO BE REMOVE	E ED
	SPECIES	UNDETERMINED / LACK OF CANOPY TO IDENTIFY
	DBH	16"
\ \	HEALTH CONDITION	VERY POOR / DEAD
4		

ZONING DIMENSIONAL TABLE-PROPOSED ZONING: LOT SIZE: +/- 6,143 SF ALLOWED / REQUIRED PROPOSED COMMENTS ZONE MR4 ZONE **BUILDING TYPE GENERAL BUILDING** APT. BUILDING LOT DIMENSIONS WIDTH (MIN.) 30 FT COMPLIES LOT DEVELOPMENT LOT COVERAGE (MAX) 90 % 65% / 3,987 SF COMPLIES 0.25 MIN 0.30 IDEAL GREEN FACTOR (MIN.) 0.32 COMPLIES BUILDING SETBACKS 3'-8" FT AT GRADE COMPLIES PRIMARY FRONT (MIN/ MAX.) 2 FT / 12 FT SECONDARY FRONT (MIN/ MAX.) 2 FT / 12 FT @ ALLEY OR ROW: 0 FT 5 FT (R) / 5 FT (L) SIDE (MIN) COMPLIES @ NR OR LHD: 10'-0" REAR (MIN) @ ALLEY OR ROW: 10 FT 20 FT COMPLIES ABUTTING NR OR LHD: 20 FT 17'-0" FT @ BAY MAIN BODY 59'-10 1/2" 200 FT COMPLIES **BUILDING WIDTH (MAX.)** FACADE BUILD OUT, FRONT STREET (MIN.) COMPLIES PRIMARY FRONT 80 % SECONDARY FRONT 65 % NOT APPLICABLE COMPLIES 15,000 SF FLOOR PLATE (MAX.) 3,498 SF COMPLIES BUILDING HEIGHT, STORIES (MIN.) 3 STORIES 4 STORIES COMPLIES **BUILDING HEIGHT, STORIES (MAX.)** 4 STORIES 10 FT 10 FT COMPLIES GROUND STORY HEIGHT (MIN.) 10 FT 10 FT COMPLIES UPPER STORY HEIGHT (MIN.) 50 FT 40 FT BUILDING HEIGHT, FEET (MAX.) COMPLIES FLAT FLAT **ROOF TYPE** COMPLIES FACADE COMPOSITION 15% / 50% COMPLIES GROUND STORY FENESTRATION (MIN.) 41% (141 SF / 466 SF) UPPER STORY FENESTRATION (MIN./ MAX.) 15% / 50% 31% (188 SF / 600 SF COMPLIES COMPLIES 20 FT BLANK WALL (MAX.) N/A **USE & OCCUPANCY** GROSS FLOOR AREA PER DU 1,500 67 FT COMPLIES LOT AREA < 5,000 SF LOT AREA > 5,000 SF 4,366 x 3 / 1,125 (11.6 DU) 15 DU NET ZERO BUILDING 4,366 x 3 / 850 (15.4 DU) COMPLIES 100% AFFORDABLE COMPLIES 936 SF (14 DU) 1/ DU OUTDOOR AMENITY SPACE (MIN.) PARKING (RESIDENTIAL) COMPLIES MIN SHORT TERM BICYCLE PARKING 0.1/DU 1.4 (2) SPACES

1 /DU (15 SPACES)

1/DU (14 SPACES MAX)

MIN LONG TERM BICYCLE PARKING

MAXIMUM PARKING (WITHIN TRANSIT AREA)

15 SPACES

5 SPACES

COMPLIES

COMPLIES

PROJECT NAME

McGrath Residences

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ARCHITECT

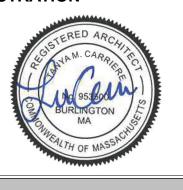


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Architectural Site Plan

A-020 McGrath Residences

3 SITE PLAN - EXISTING TREE PLAN 1/16" = 1'-0"

10. DEVELOPMENT STANDARDS

Green Score

Table 10.4.1 Green Score Calculation

	Credit	Multiplier
Soils		
Landscaped area with a soil depth < 24 inches	actual sf	0.3
Landscaped area with a soil depth => 24 inches	actual sf	0.6
Pervious Paving with 6 to 24 inches of subsurface soil or gravel	actual sf	0.2
Pervious Paving with more than 24 inches of subsurface soil or gravel	actual sf	0.5
Groundcovers		
Turfgrass, mulch, and inorganic surfacing materials	actual sf	0.1
Plants		
Vegetation less than two (2) feet tall at maturity	actual sf	0.2
Vegetation at least two (2) feet tall at maturity	12 sf.	0.3
Trees		
SMALL TREE	50 sf.	0.6
Large Tree	450 sf.	0.6
Preserved Tree	65 sf.	0.8
Engineered Landscape		
Vegetated Wall	actual sf	0.1
Rain gardens, bioswales, and stormwater PLANTERS.	actual sf	1.0
Green Roof with up to 6" of growth medium	actual sf	0.1
Green Roof with 6"-10" of growth medium	actual sf	0.4
Green Roof of 10"-24" growth medium	actual sf	0.6
Green Roof of over 24" growth medium		per individual landscape elements

Green Score is a performance-based environmental landscape standard measured as a ratio of the weighted value of all landscape elements to the total land area of a lot.

394 McGrath Hwy 6,086.73 SF Total

	Multiplier	Bonus	Area in Square Feet	
Soils Landscaped Area with a soil depth => 24 inches	.6	DP .1	645.70	451.99
Soils Pervious Paving with 6 to 24 inches of subsurface soil or gravel	.2	DP .1	894.60	268.38
Groundcovers Turfgrass, mulch, and inorganic surfacing materials	.1	NS .1 DP .1	101.03	30.34
Plants Vegetation less than two feet tall at maturity	.2	NS .1 PV .1 DP .1	325.76	162.88
Plants Vegetation at least two feet tall at maturity (per plant)	.3	NS .1 PV .1 DP .1	12 sf. (30)	216.00
Trees Large Tree (per plant)	.6	NS .1 DP .1	450 sf. (1)	360.00
Trees Small Tree (per plant)	.6	NS .1 PV .1 DP .1	50 sf. (2)	90.00
Engineered Landscape Green Roof with up to 6" of growth medium	.1	NS .1	1,470.97	294.19
Engineered Landscape Green Roof of 10"-24" growth medium	.6	NS .1	110.65	77.46
Total				1,951.24
Green Score Bonus Publicly Visible Landscape = PV = .1 Native Species = NS = .1 De-Paved Lot Area = DP = .1				

1,951.24 / 6,086.73 = .32 Green Score

5. Calculation

- a. Green Score is calculated as follows:
 - i. Determine total LOT AREA.
 - ii. Calculate the area of each proposed landscape element for each category identified in the first column of Table 10.4.1. Certain types of plantings use the number of individual plants multiplied by an equivalent square footage when indicated in the second column of Table 10.4.1.
 - iii. Multiply the actual square footage, or the equivalent square footage, of each landscape element by the multiplier specified for each landscape element in the third column of Table 10.4.1 plus any bonus on Table 10.4.2 to determine the weighted score of each element.
 - iv. Add the weighted score of all landscape elements together.
 - v. Divide the resulting sum by the area of the LOT to determine the final Green Score.
 - vi. If necessary, redesign the landscape plan to achieve the required GREEN SCORE.
- b. Bonuse
 - i. Review Boards may establish additional bonuses



GREEN SCORE CALCULATIONS

394 McGRATH HWY

SOMERVILLE, MA

AT GRADE LANDSCAPE

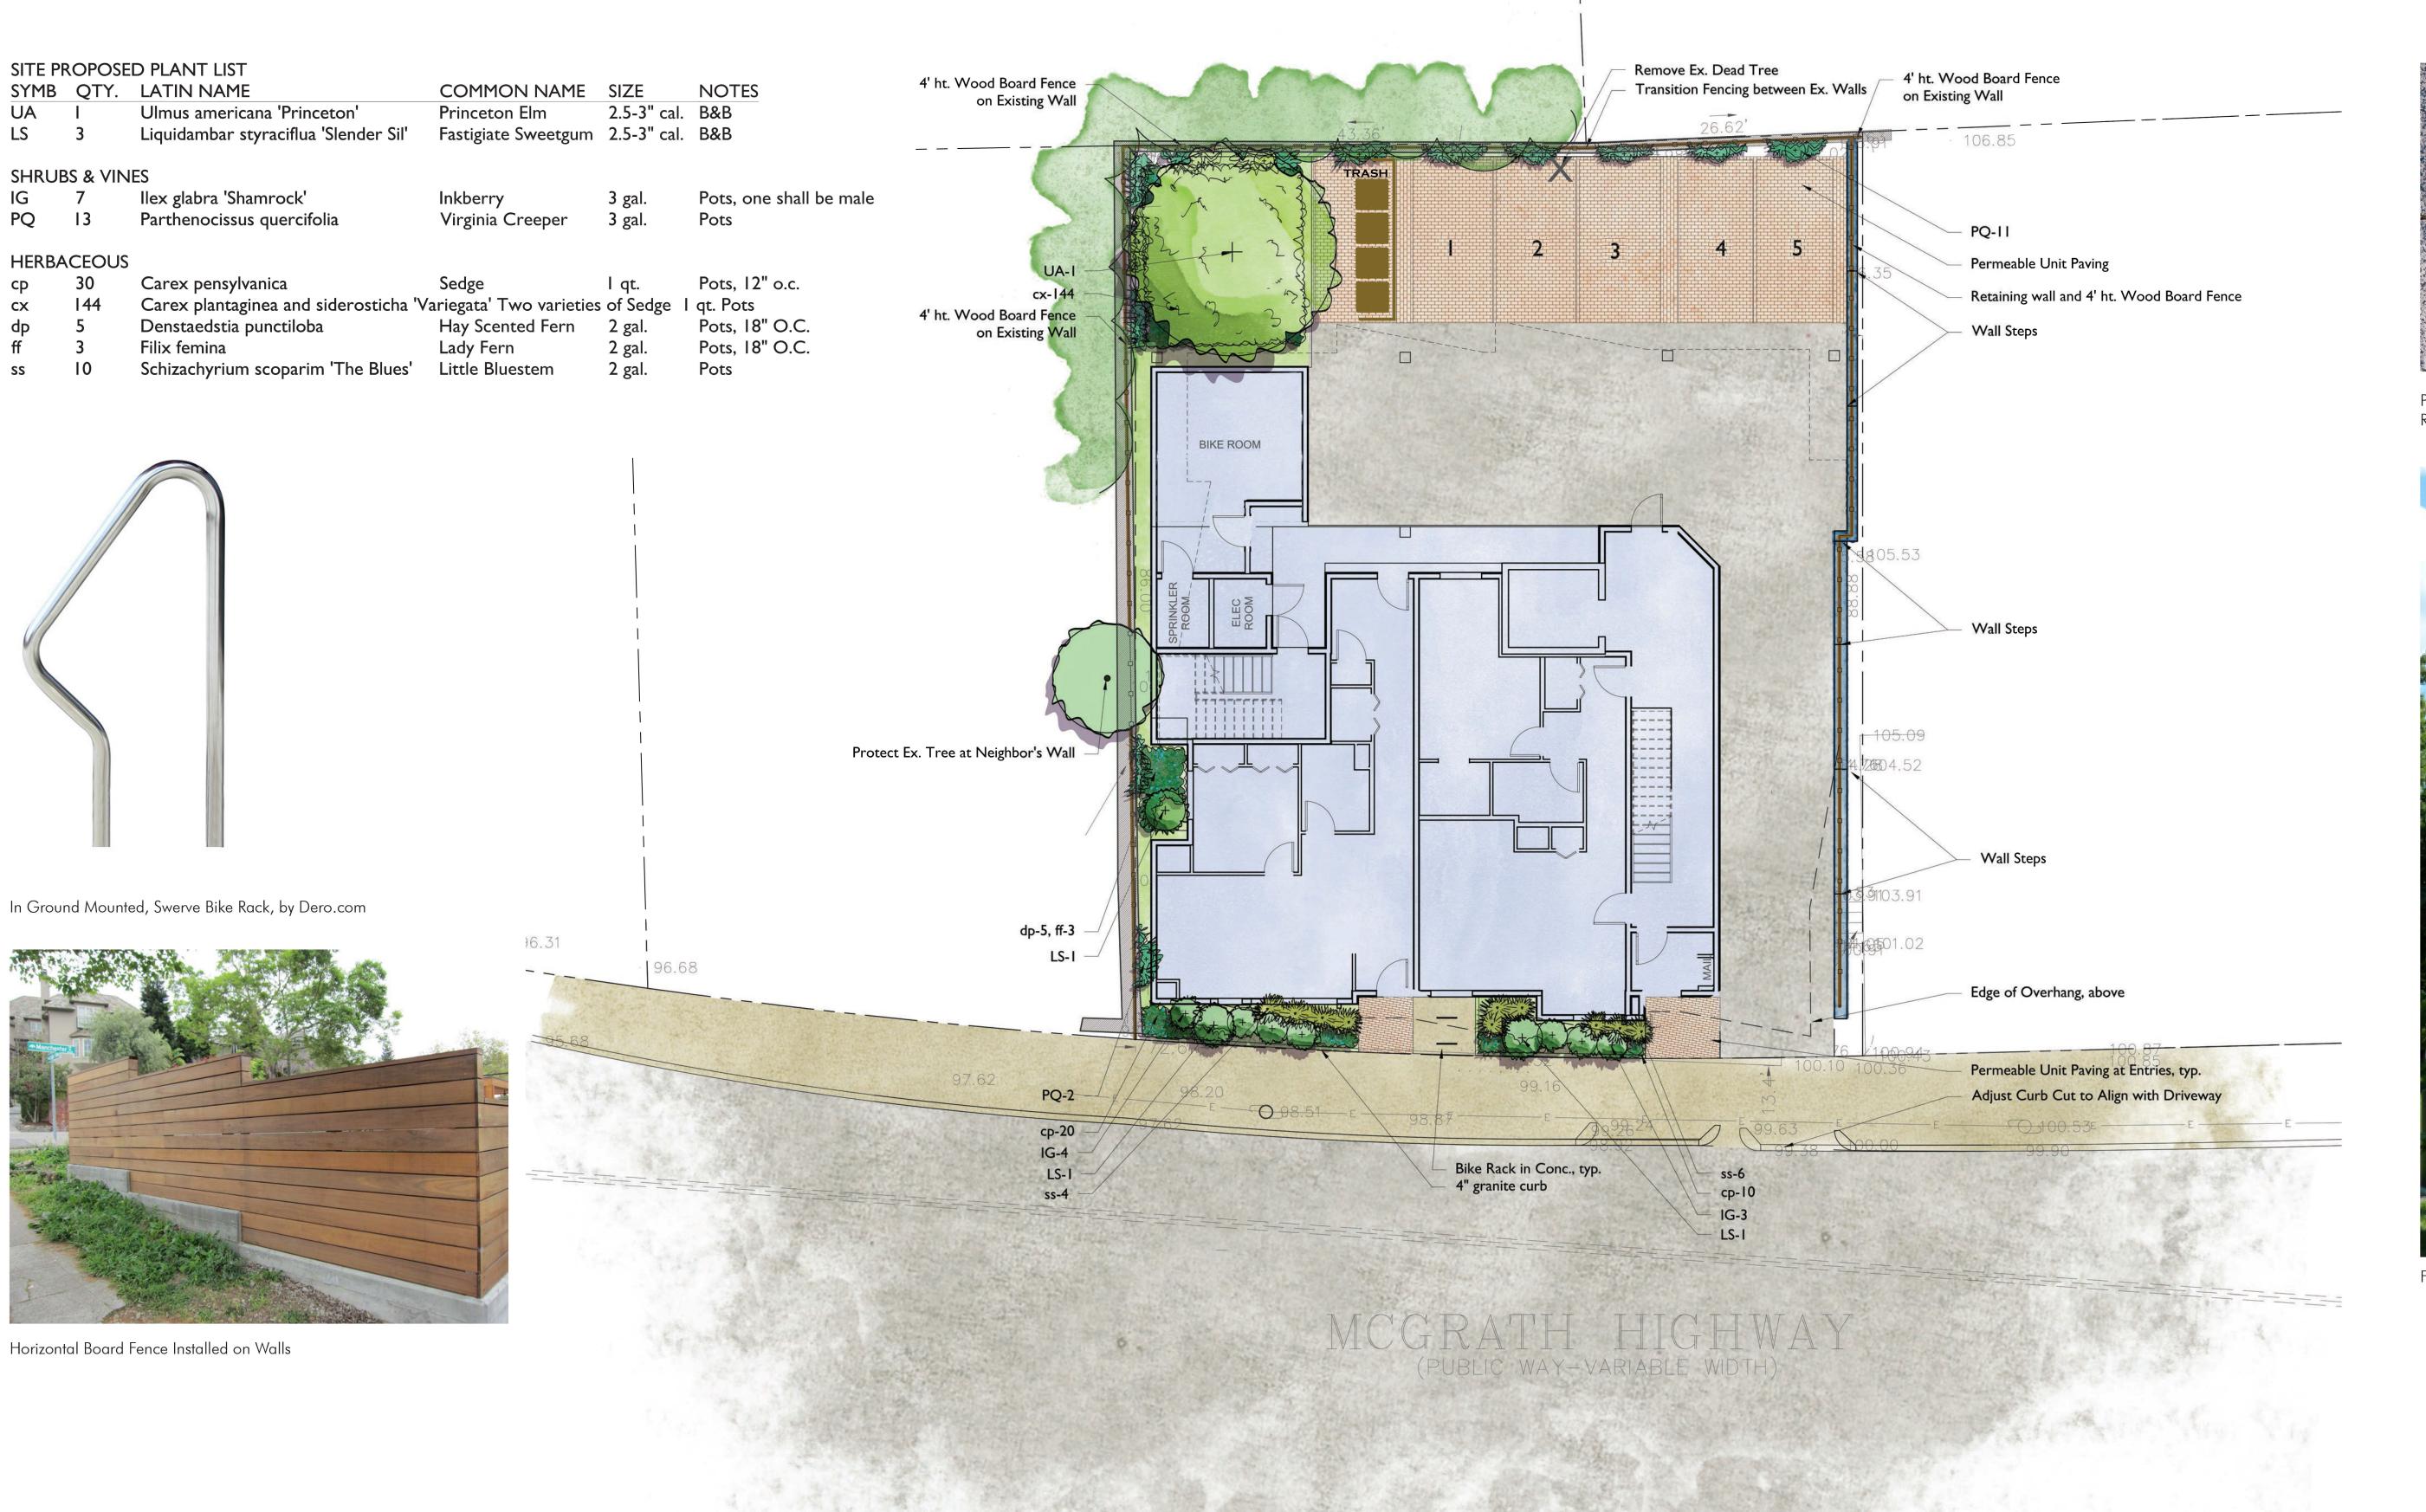


ROOF TOP











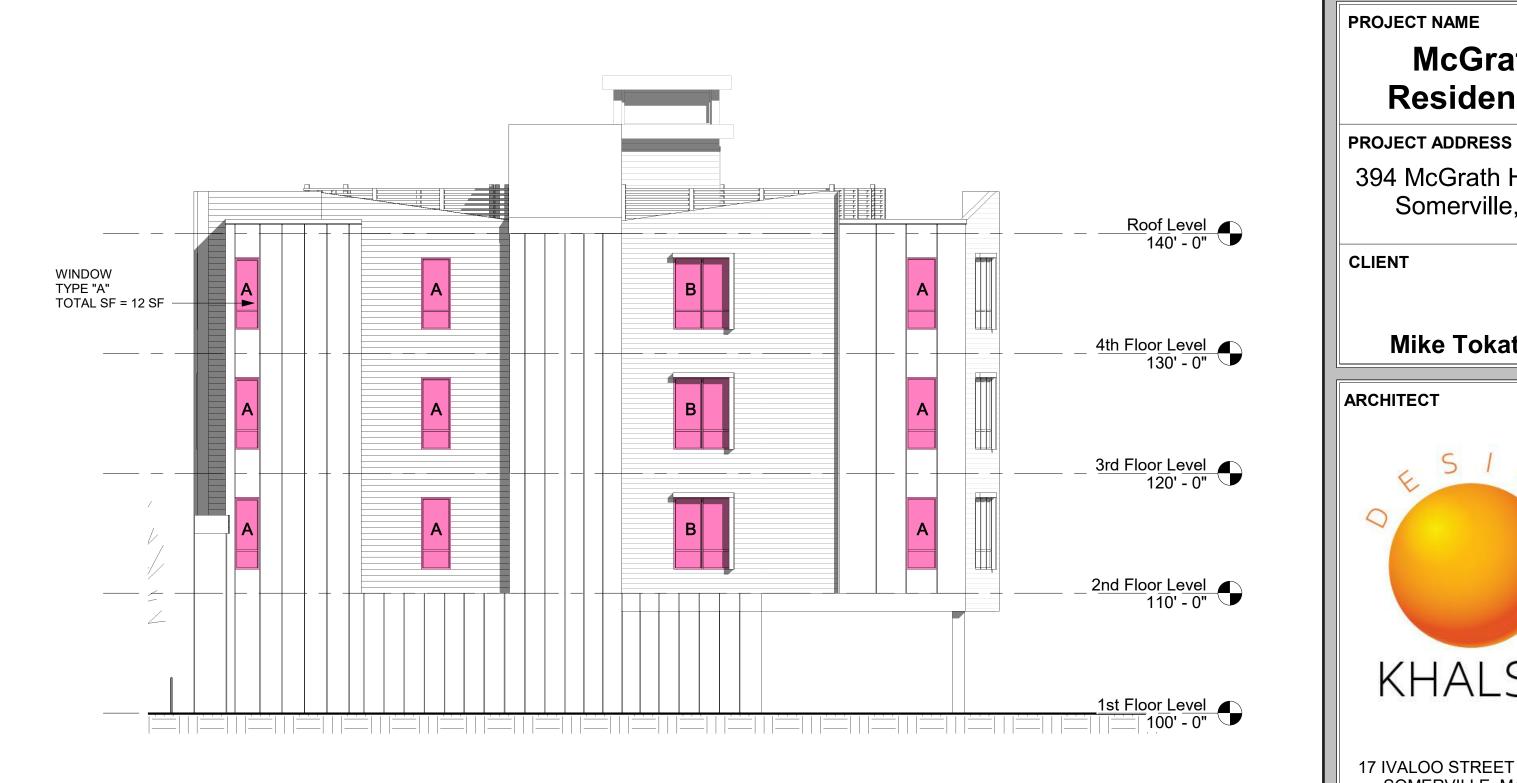
Permeable Paver - Unilock Eco-Priora Umbariano Winter Marvel Reflectance .35



Fastigiate Sweetgum



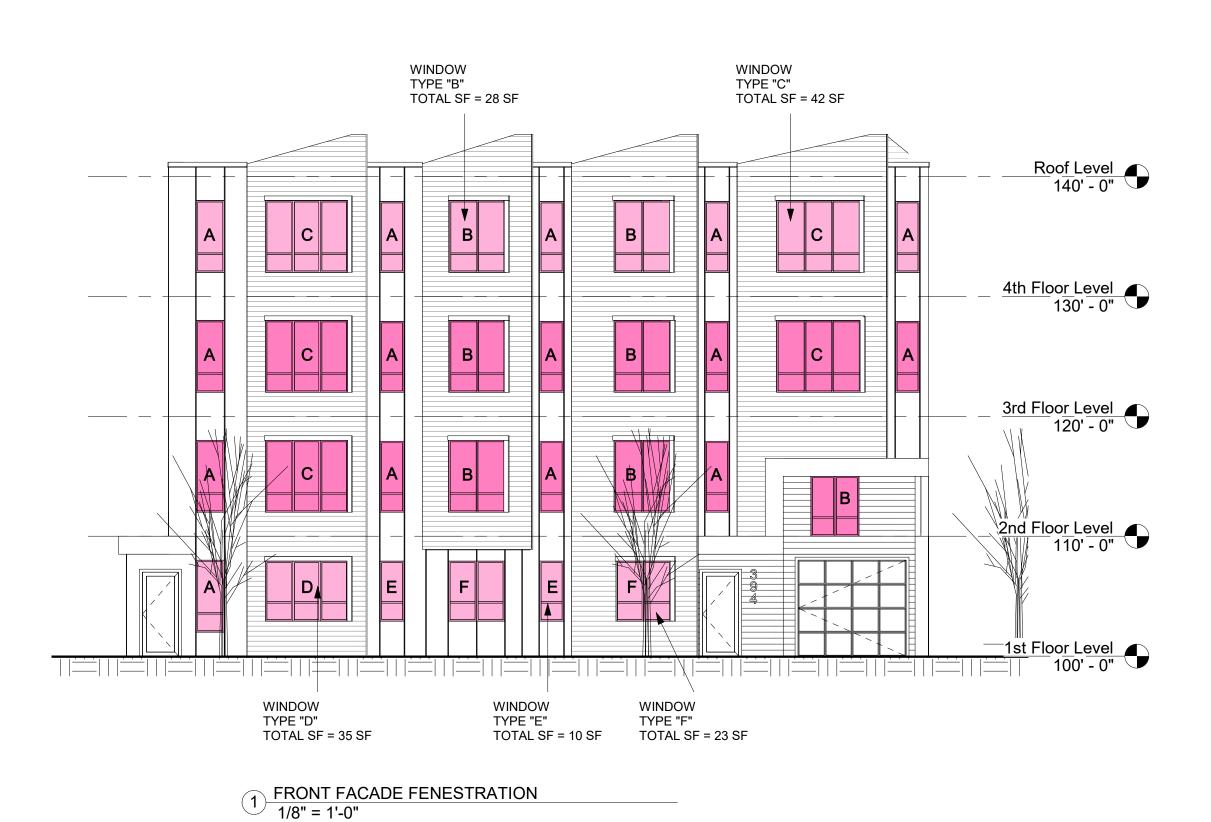




2 SIDE FACADE (North) FENESTRATION 1/8" = 1'-0"

4 REAR FACADE (West) FENESTRATION
1/8" = 1'-0"







3 SIDE FACADE (South) FENESTRATION 1/8" = 1'-0"

WINDOW TOTALS

TYPE A: 31 TOTAL @ 12 SF EACH = 372 SF TYPE B: 24 TOTAL @ 28 SF EACH = 672 SF TYPE C: 12 TOTAL @ 42 SF EACH = 504 SF TYPE D: 1 TOTAL @ 35 SF EACH = 35 SF TYPE E: 3 TOTAL @ 10 SF EACH = 30 SF TYPE F: 4 TOTAL @ 23 SF EACH = 92 SF 75 WINDOWS / 1,705 SF OF WINDOWS

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McGrath

Residences

394 McGrath Highway Somerville, MA

Mike Tokatlyan

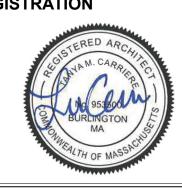
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17 IVALOO STREET SUITE 400 SOMERVILLE, MA 02143

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Fenestration Elevations

A-021

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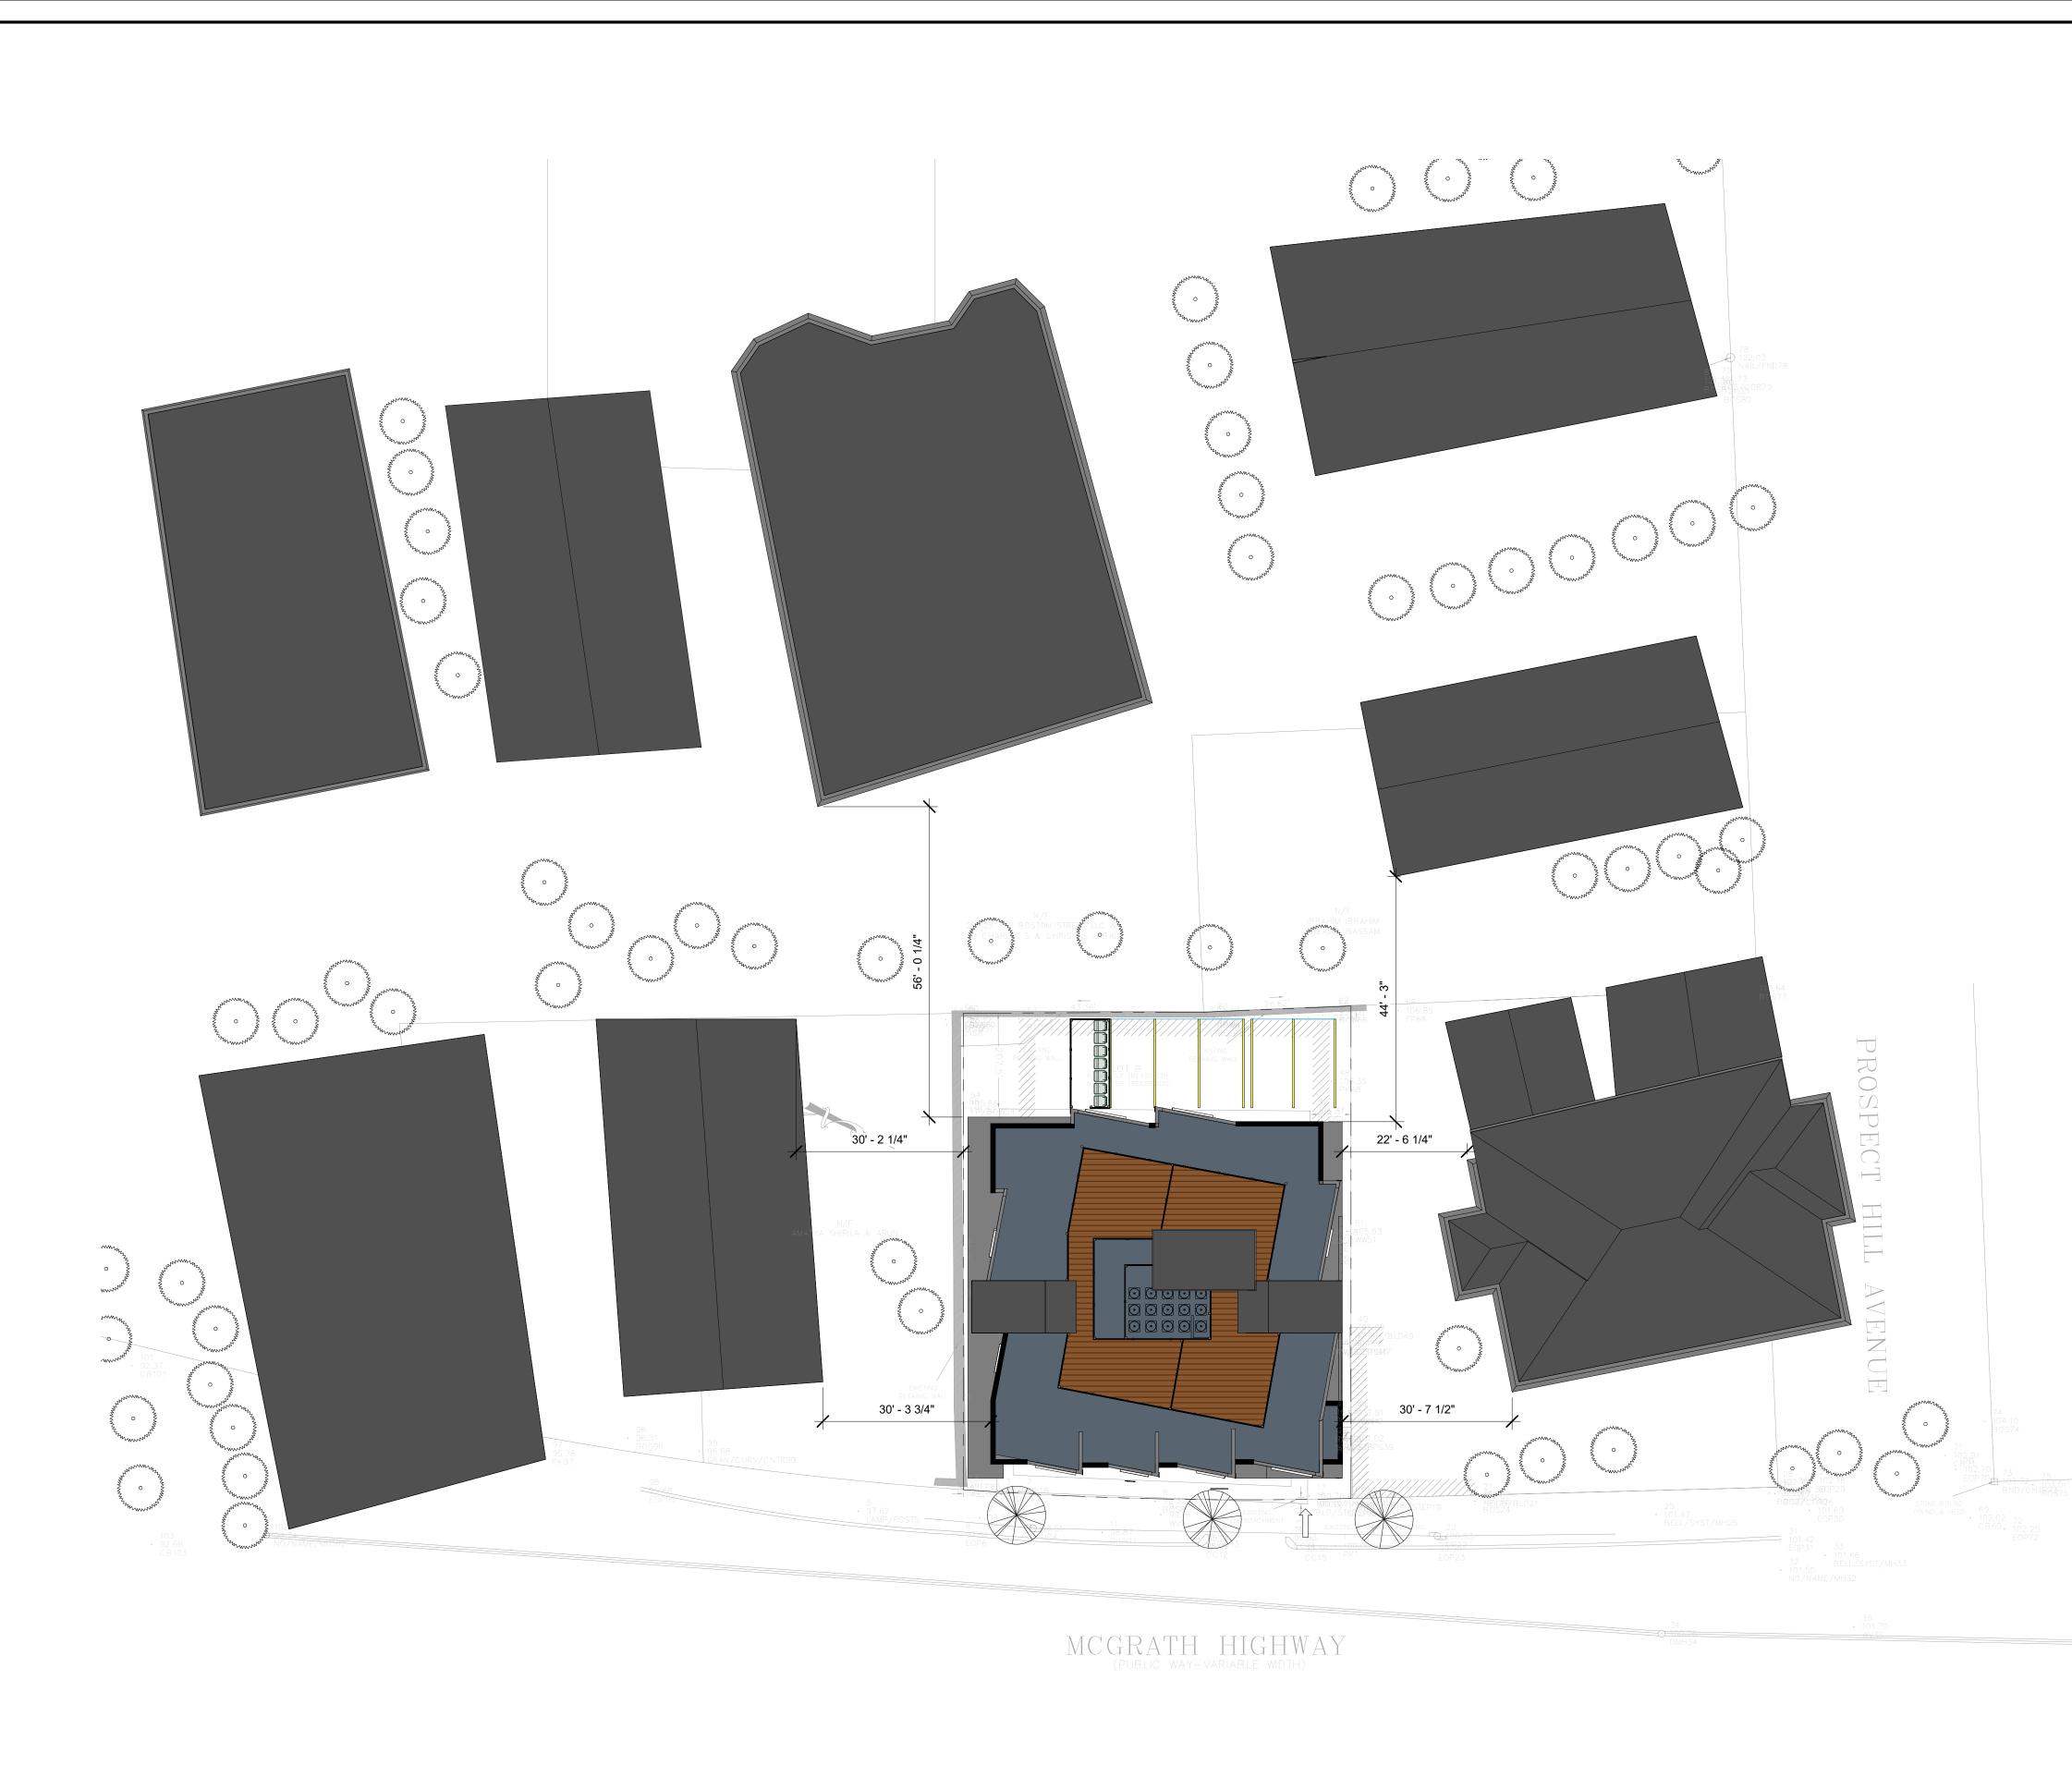
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Abutting Properties Plan



McGrath Residences

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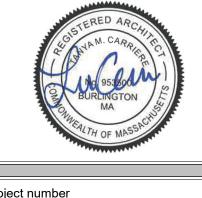


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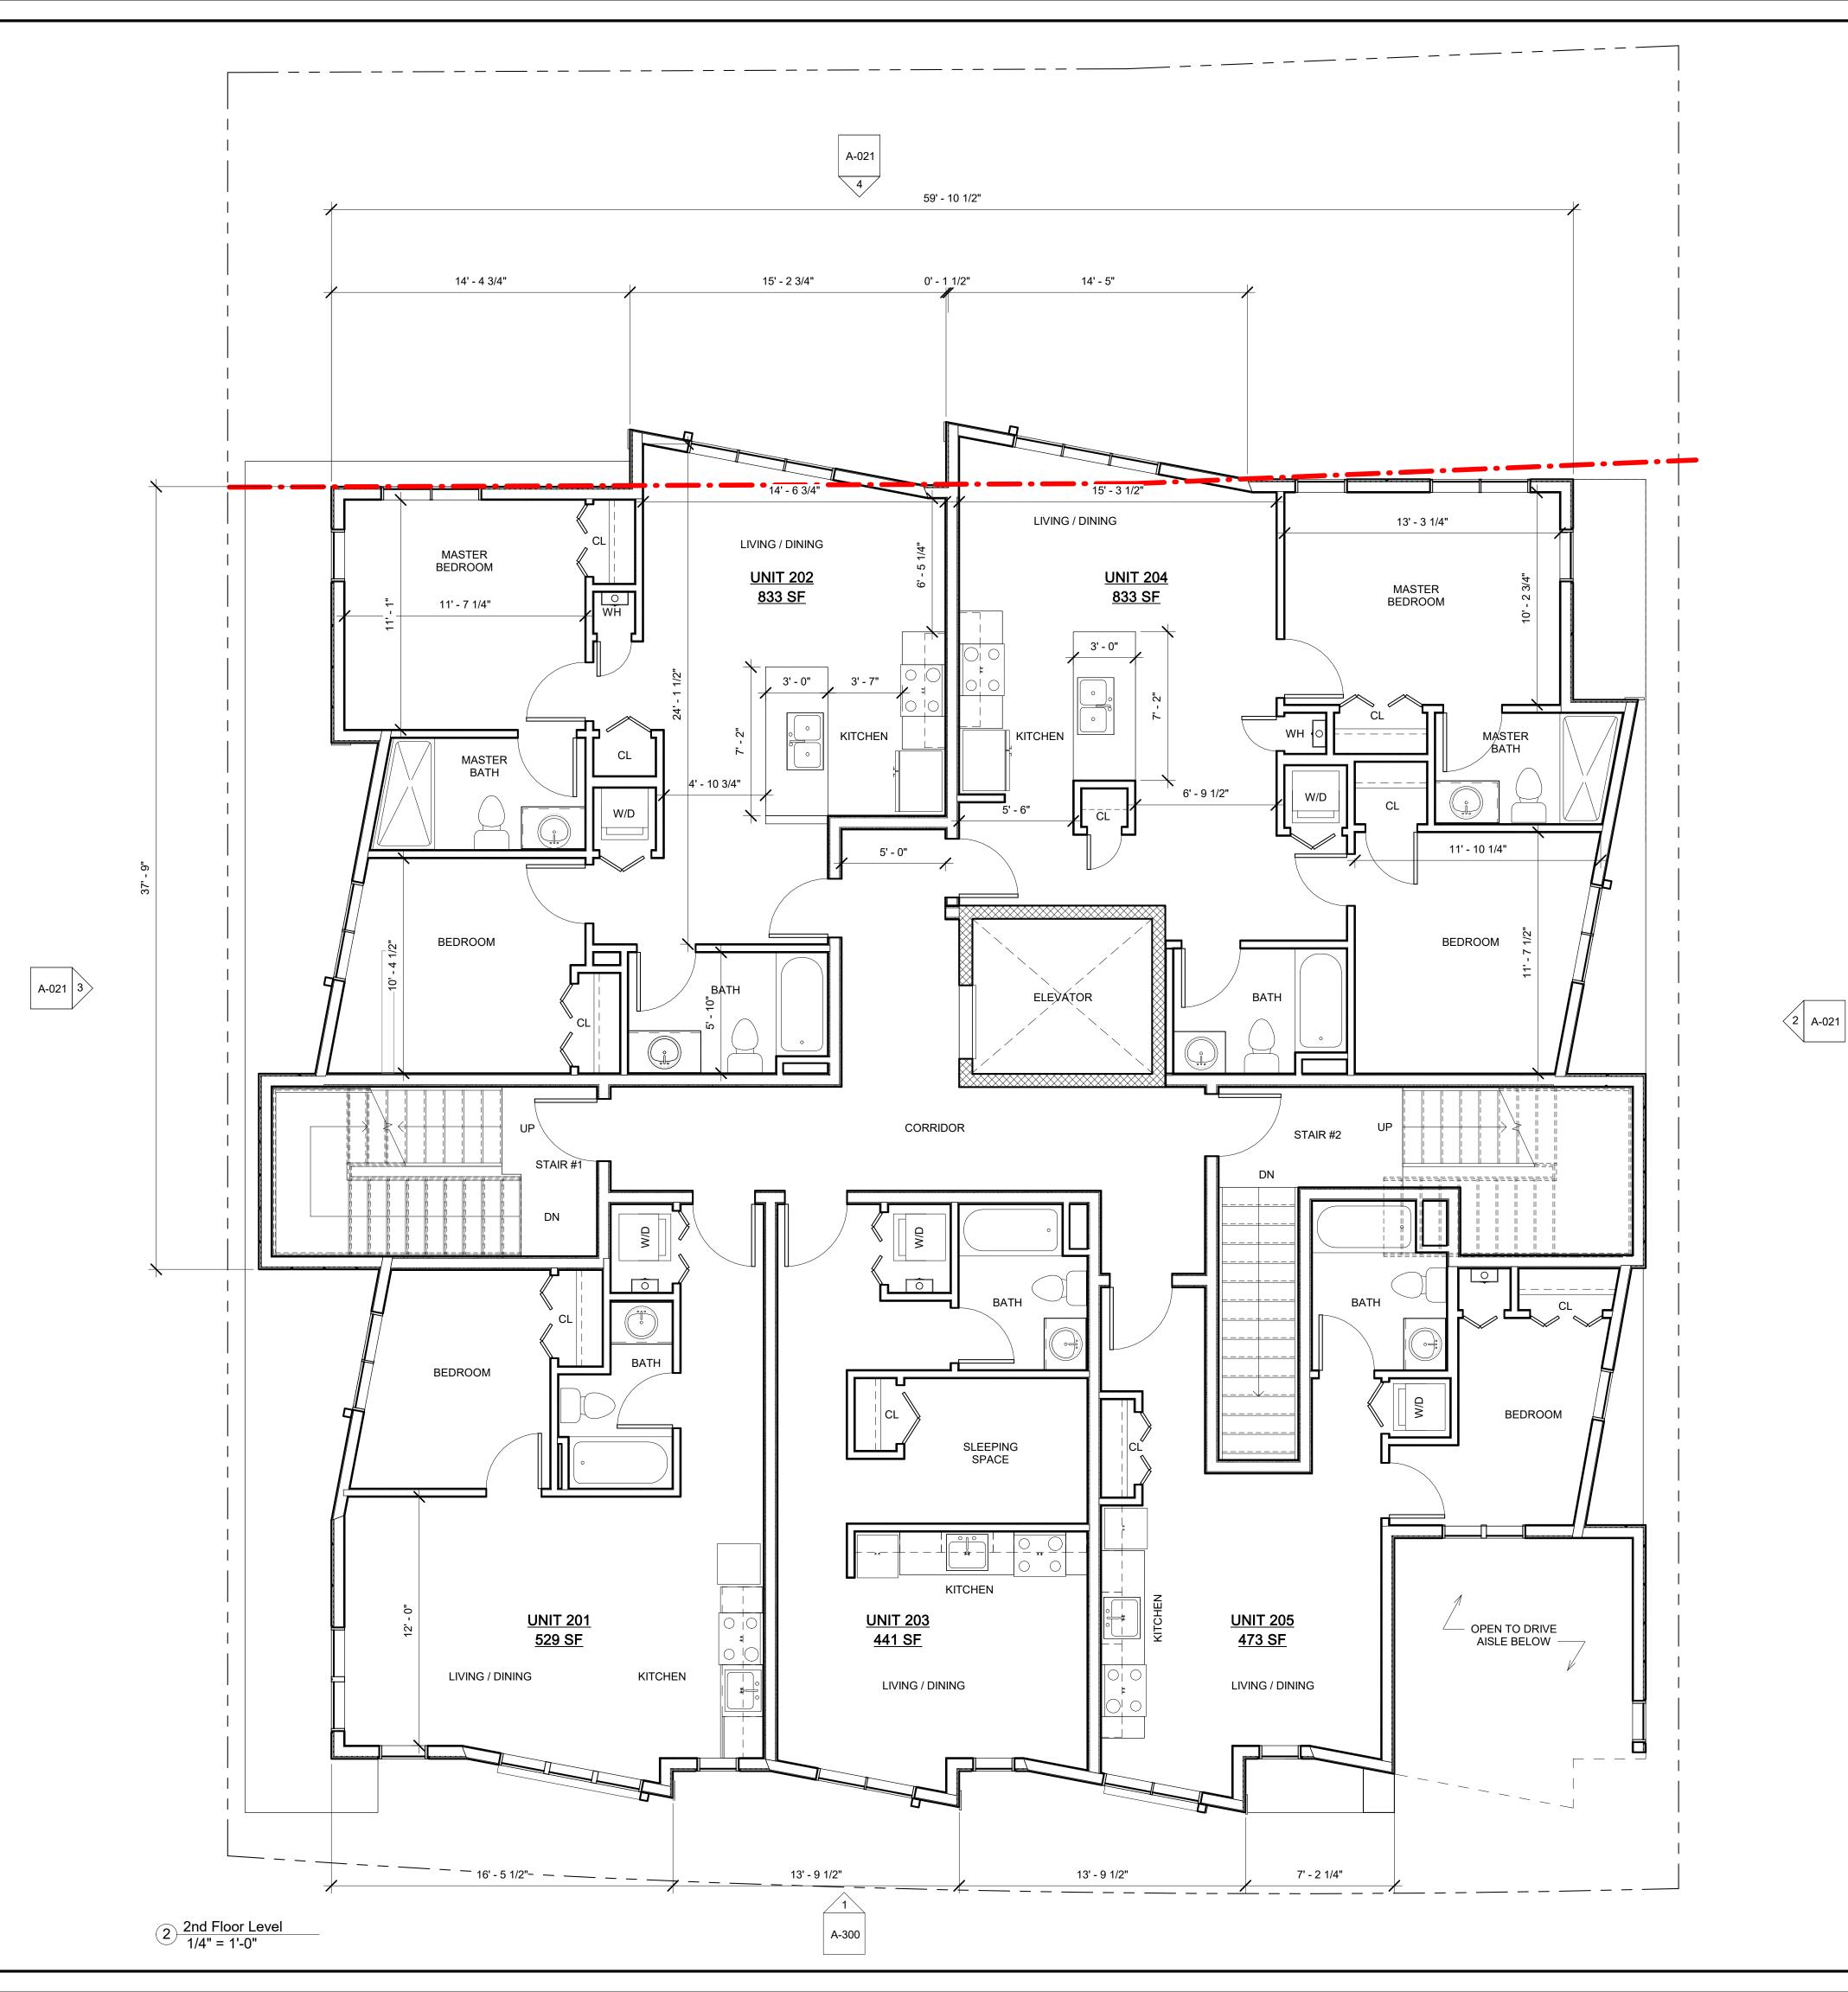
1st Floor Plan

A-100 McGrath Residences

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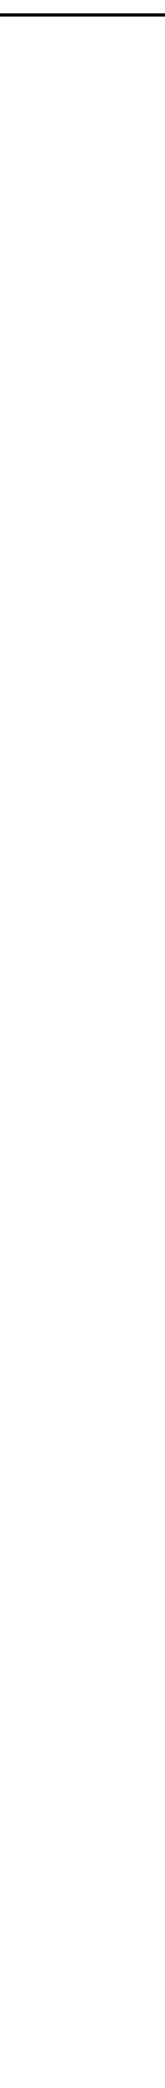


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McGrath

Residences

394 McGrath Highway Somerville, MA



2 A-021

59' - 10 1/2"

27' - 9 3/4"

6' - 9 1/2"

W/D

STAIR #2

13' - 3 1/4"

MASTER BEDROOM

MASTER

11' - 10 1/4"

BEDROOM

BEDROOM

KITCHEN

<u>UNIT 303</u> <u>863 SF</u>

15' - 4 3/4"

15' - 5 1/4"

LIVING / DINING

15' - 3 1/2"

<u>UNIT 304</u>

834 SF

LIVING / DINING

KITCHEN

MASTER

BATH

MASTER

13' - 9 1/2"

BEDROOM

15' - 2 3/4"

<u>UNIT 302</u>

<u>795 SF</u>

LIVING / DINING

4' - 10 3/4"

KITCHEN

CORRIDOR

MASTER

BATH

MASTER

4' - 8 1/4"

BEDROOM

9' - 1 1/2"

59' - 6 1/4"

CL

14' - 9"

MASTER BEDROOM

11' - 7 1/4"

MASTER BATH

BEDROOM

STAIR #1

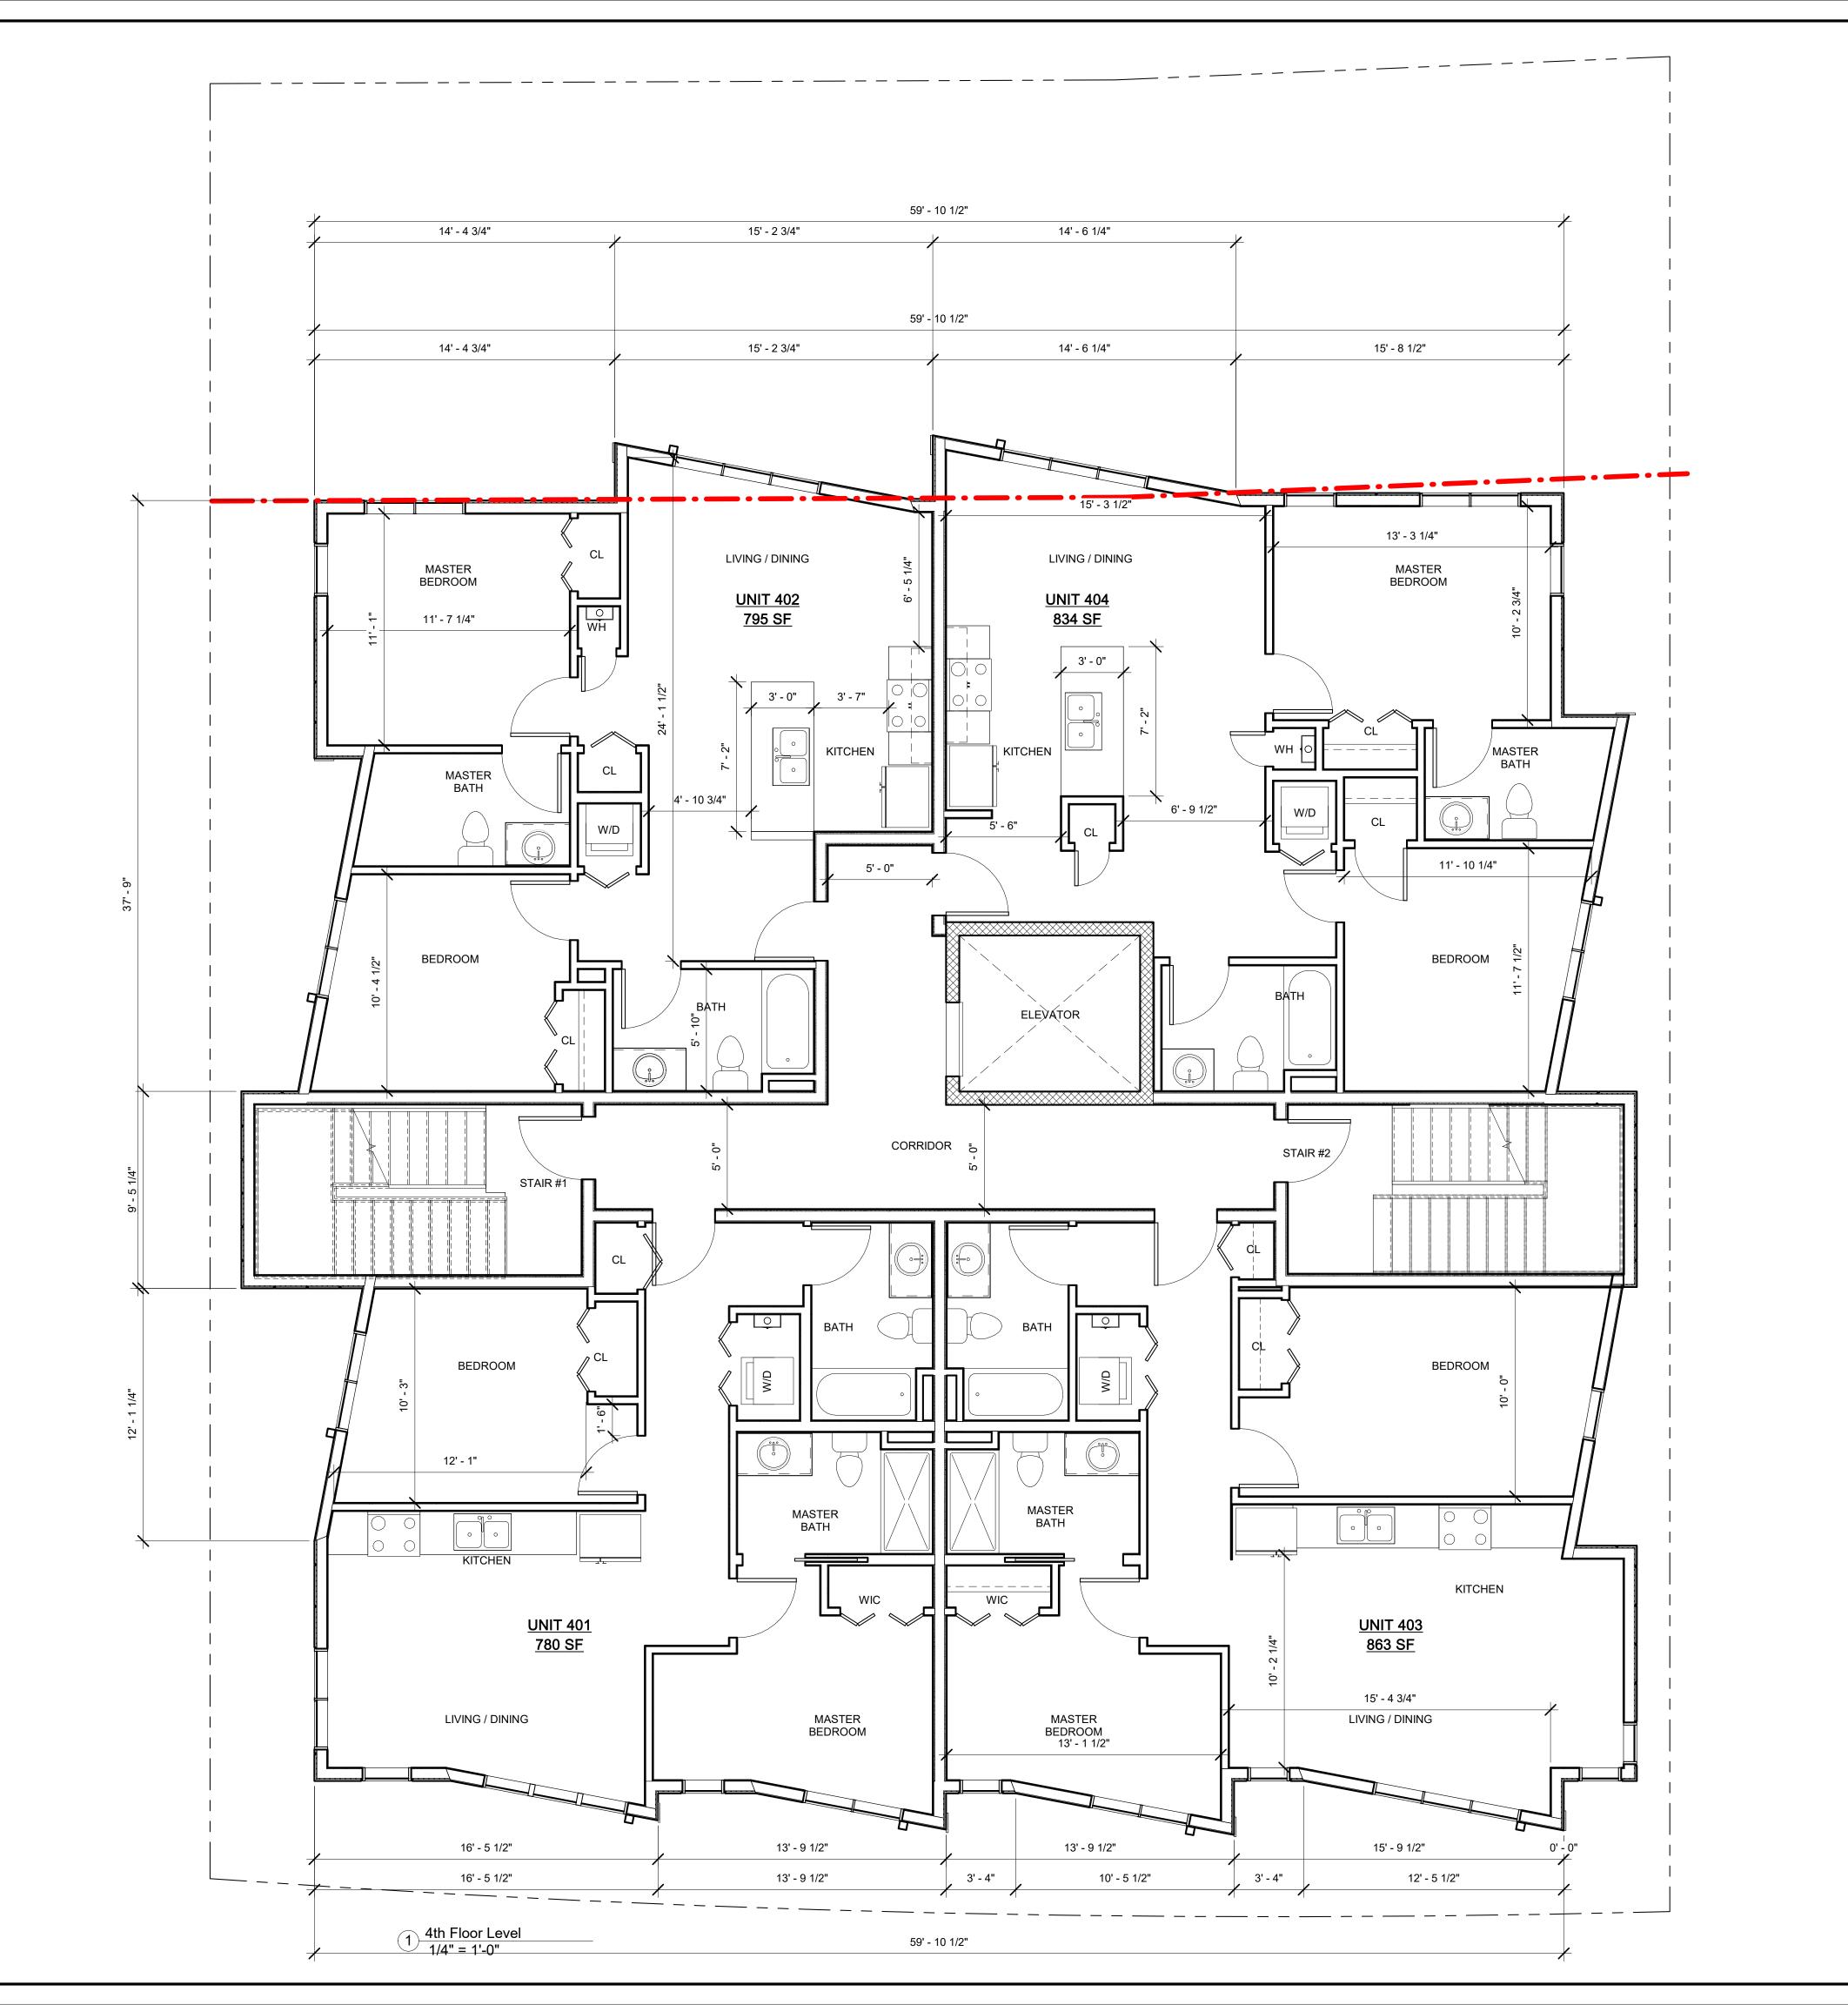
BEDROOM

<u>UNIT 301</u> <u>780 SF</u>

LIVING / DINING

16' - 1 1/4"

3rd Floor Level 1/4" = 1'-0"



McGrath Residences

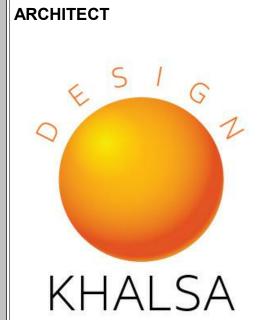
PROJECT ADDRESS

394 McGrath Highway
Somerville, MA

CLIENT

Mike Tokatlyan

LUTECT

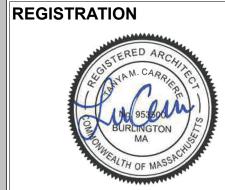


17 IVALOO STREET SUITE 400 SOMERVILLE, MA 02143 TELEPHONE: 617-591-8682 FAX: 617-591-2086

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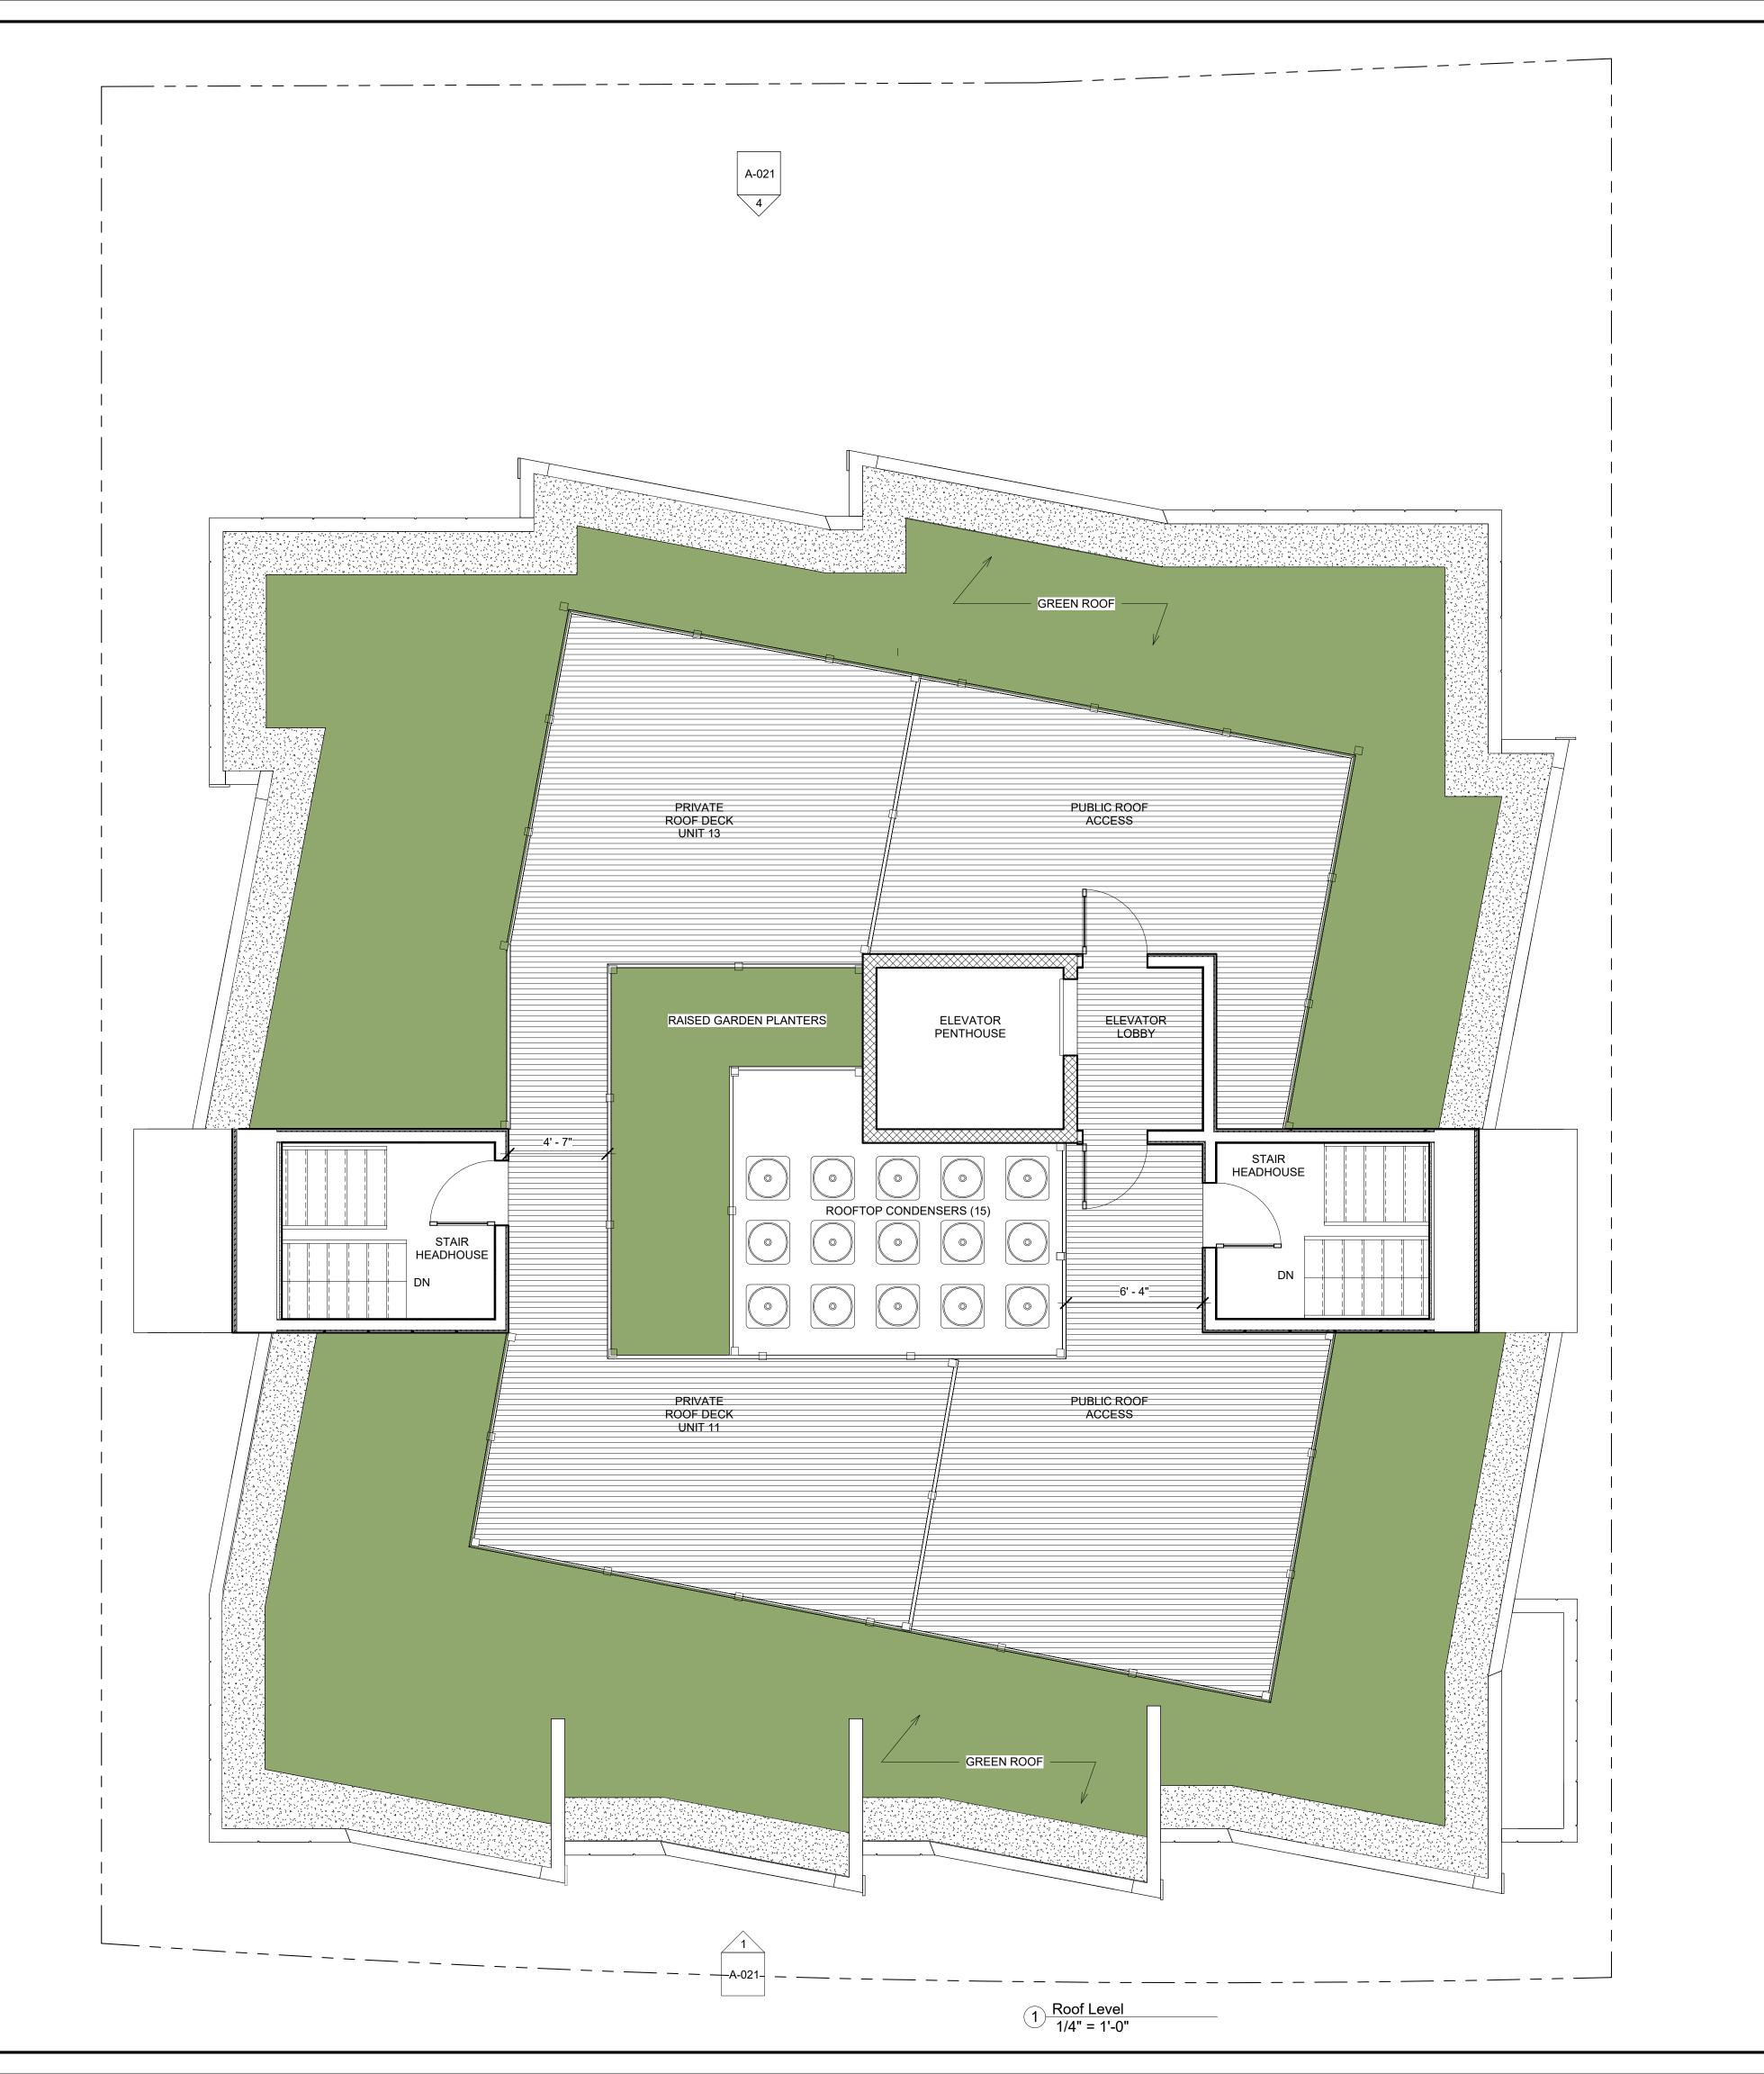


Projec	t number	1905
Date		12/01/2
Drawn	by	W
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REVI	SIONS	
No.	Description	Date
	1	

4th Floor Plan

A-103

McGrath Residences



McGrath Residences

ALECT ADDDE

394 McGrath Highway
Somerville, MA

CLIENT

Mike Tokatlyan





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STRATION

Project number



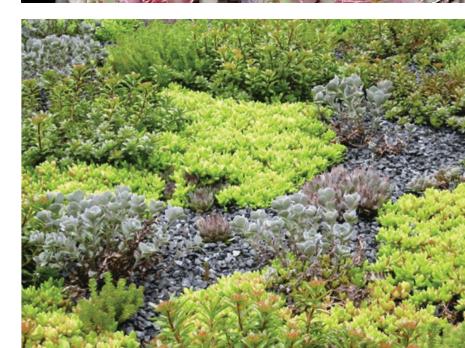
Date		12/01/21
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Roof Plan

A-105







Sedum Extensive Greenroof

106.85

(PUBLIC WAY-VARIABLE WIDTH)





Pedestal Pavers & Intensive Greenroof



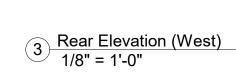


















Side Elevation (South)
1/8" = 1'-0"

PROJECT NAME **McGrath** Residences

PROJECT ADDRESS

394 McGrath Highway Somerville, MA

CLIENT

Mike Tokatlyan

ARCHITECT



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Exterior Elevations

A-300



1 McGrath View 1



2 McGrath View 2



3 Rear View



4 Rear View 2

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PROJECT NAME

PROJECT ADDRESS

CLIENT

ARCHITECT

McGrath

Residences

394 McGrath Highway Somerville, MA

Mike Tokatlyan

KHALSA

17 IVALOO STREET SUITE 400 SOMERVILLE, MA 02143

CONSULTANTS:



Project n	umber	19055
Date		12/01/21
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Scale		
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No.	Description	Date

Exterior Perspectives

A-301

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	No.	Description	Date
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Street View





PROJECT NAME

McGrath Residences

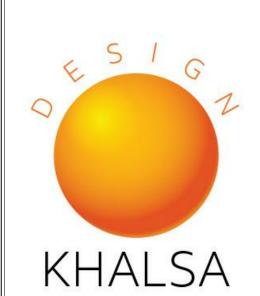
PROJECT ADDRESS

394 McGrath Highway Somerville, MA

CLIENT

Mike Tokatlyan

ARCHITECT



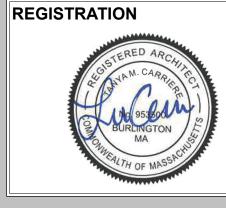
17 IVALOO STREET SUITE 400 SOMERVILLE, MA 02143

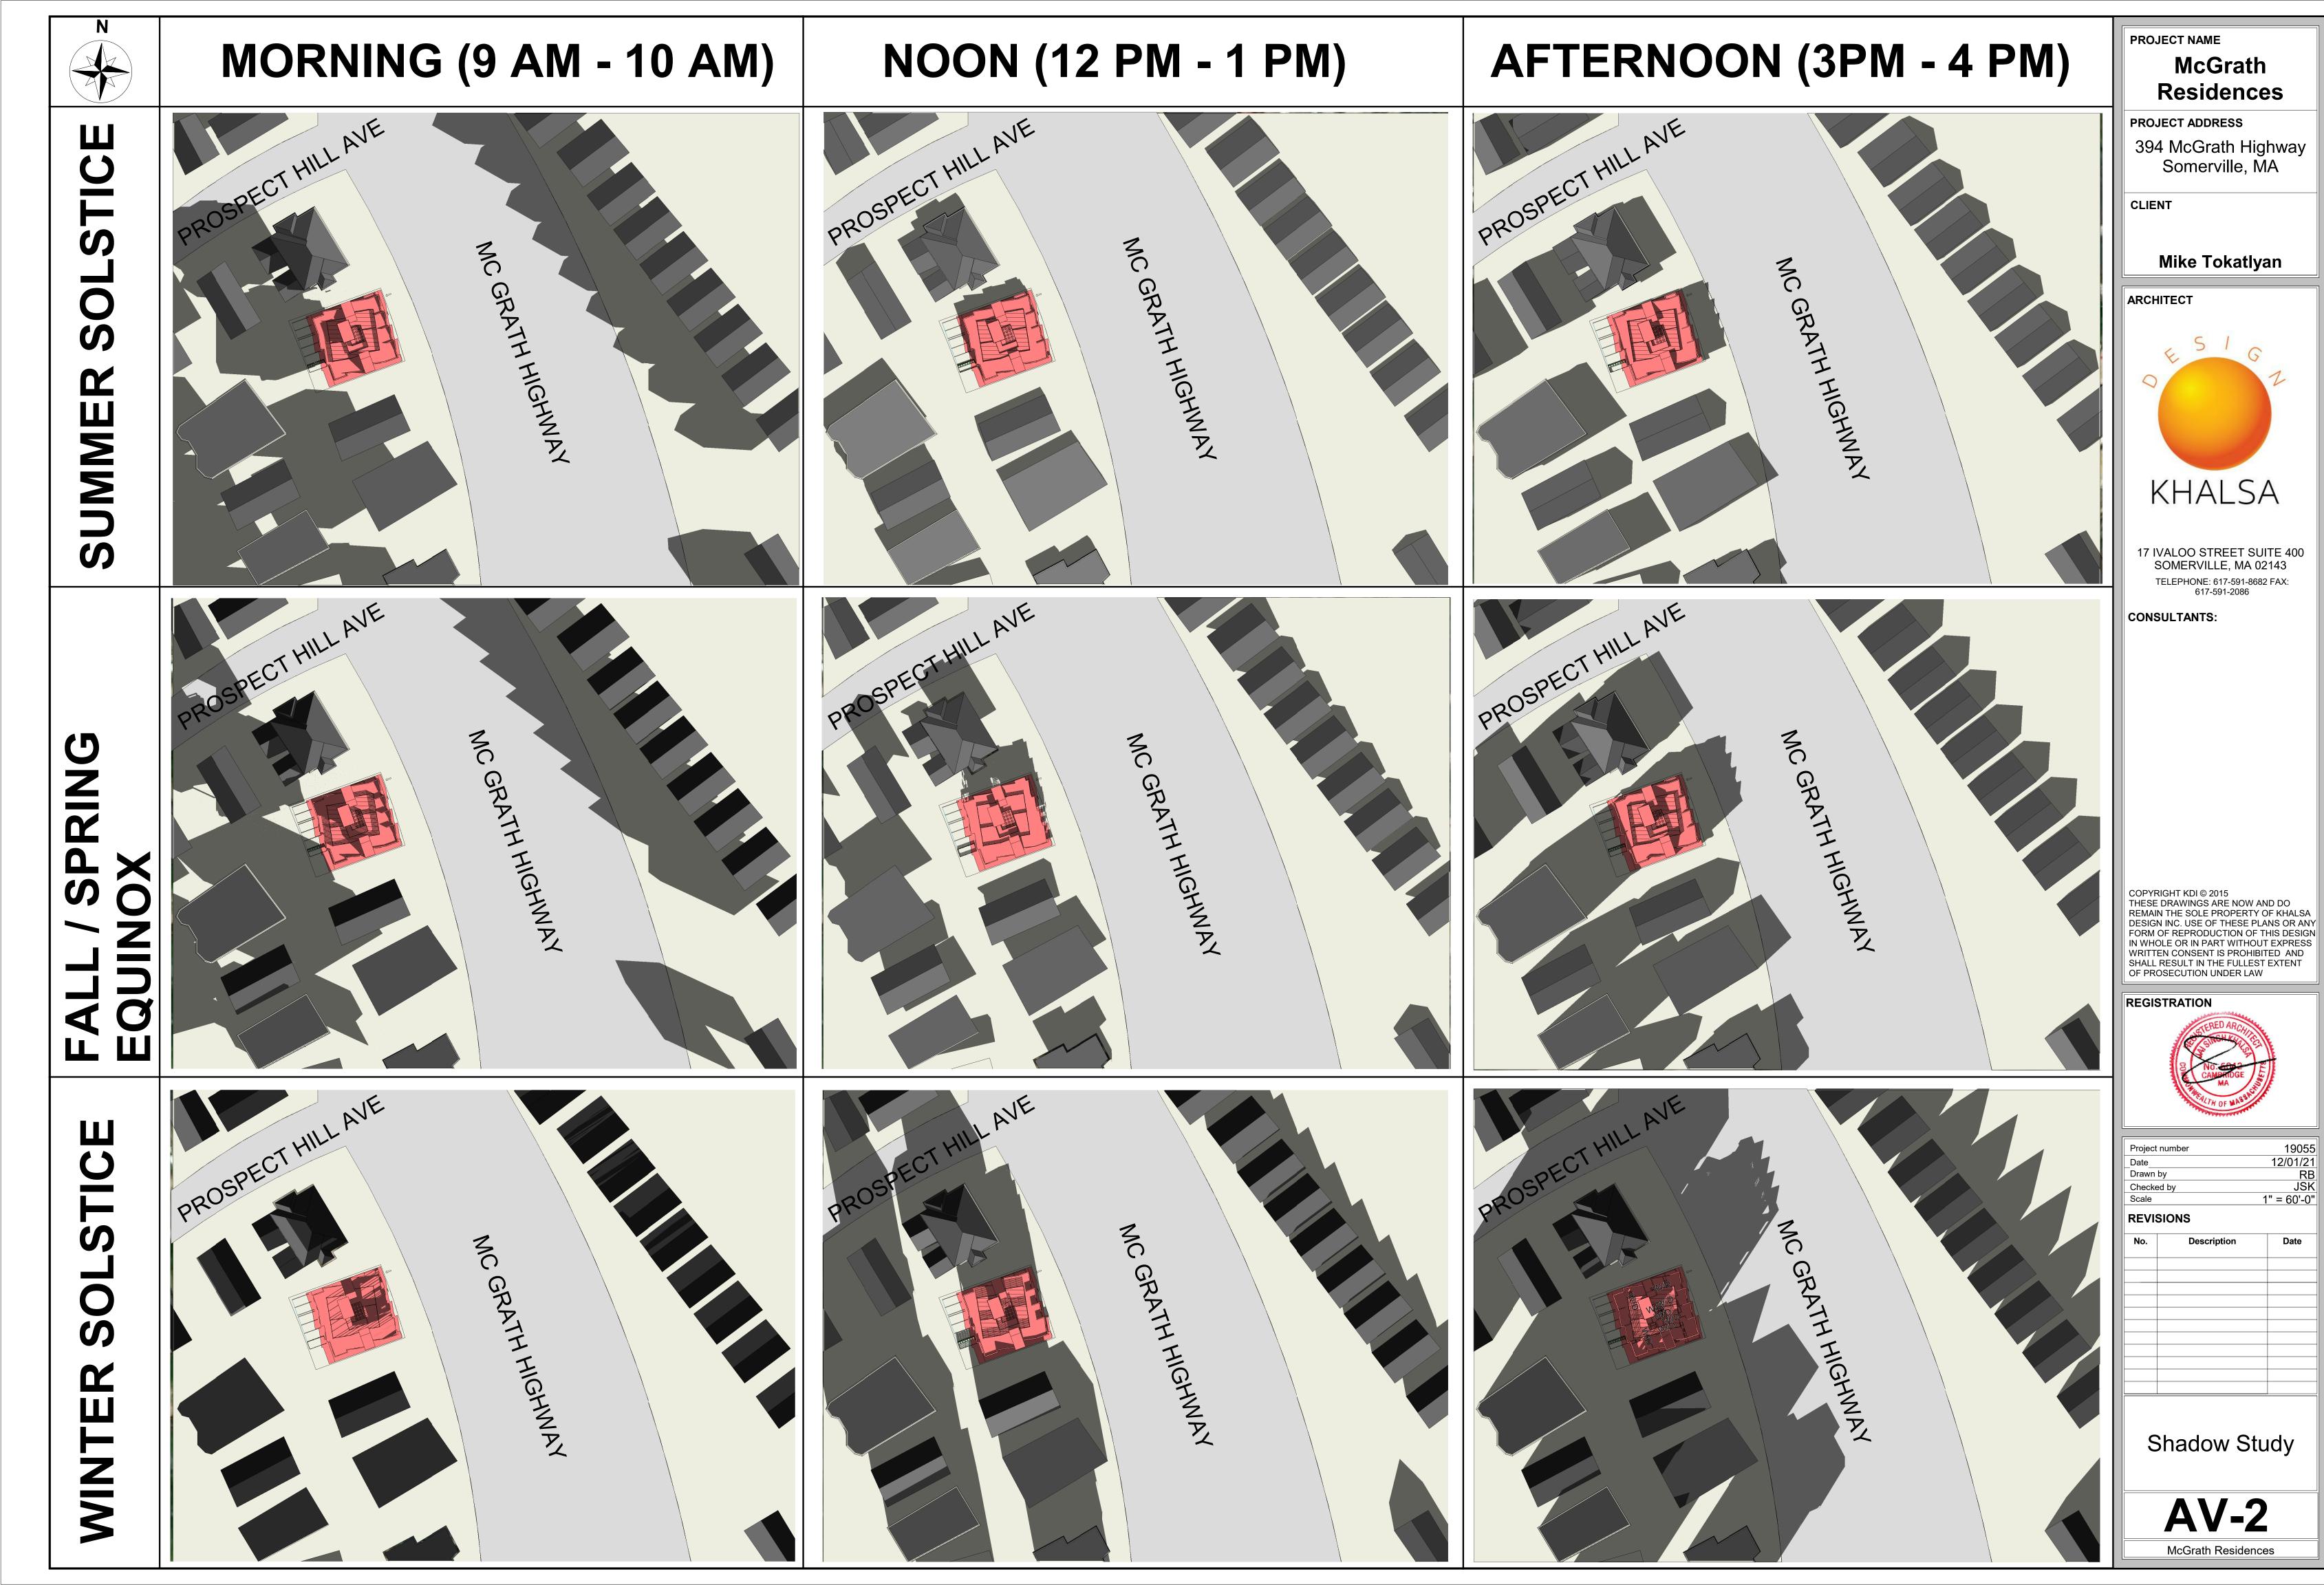
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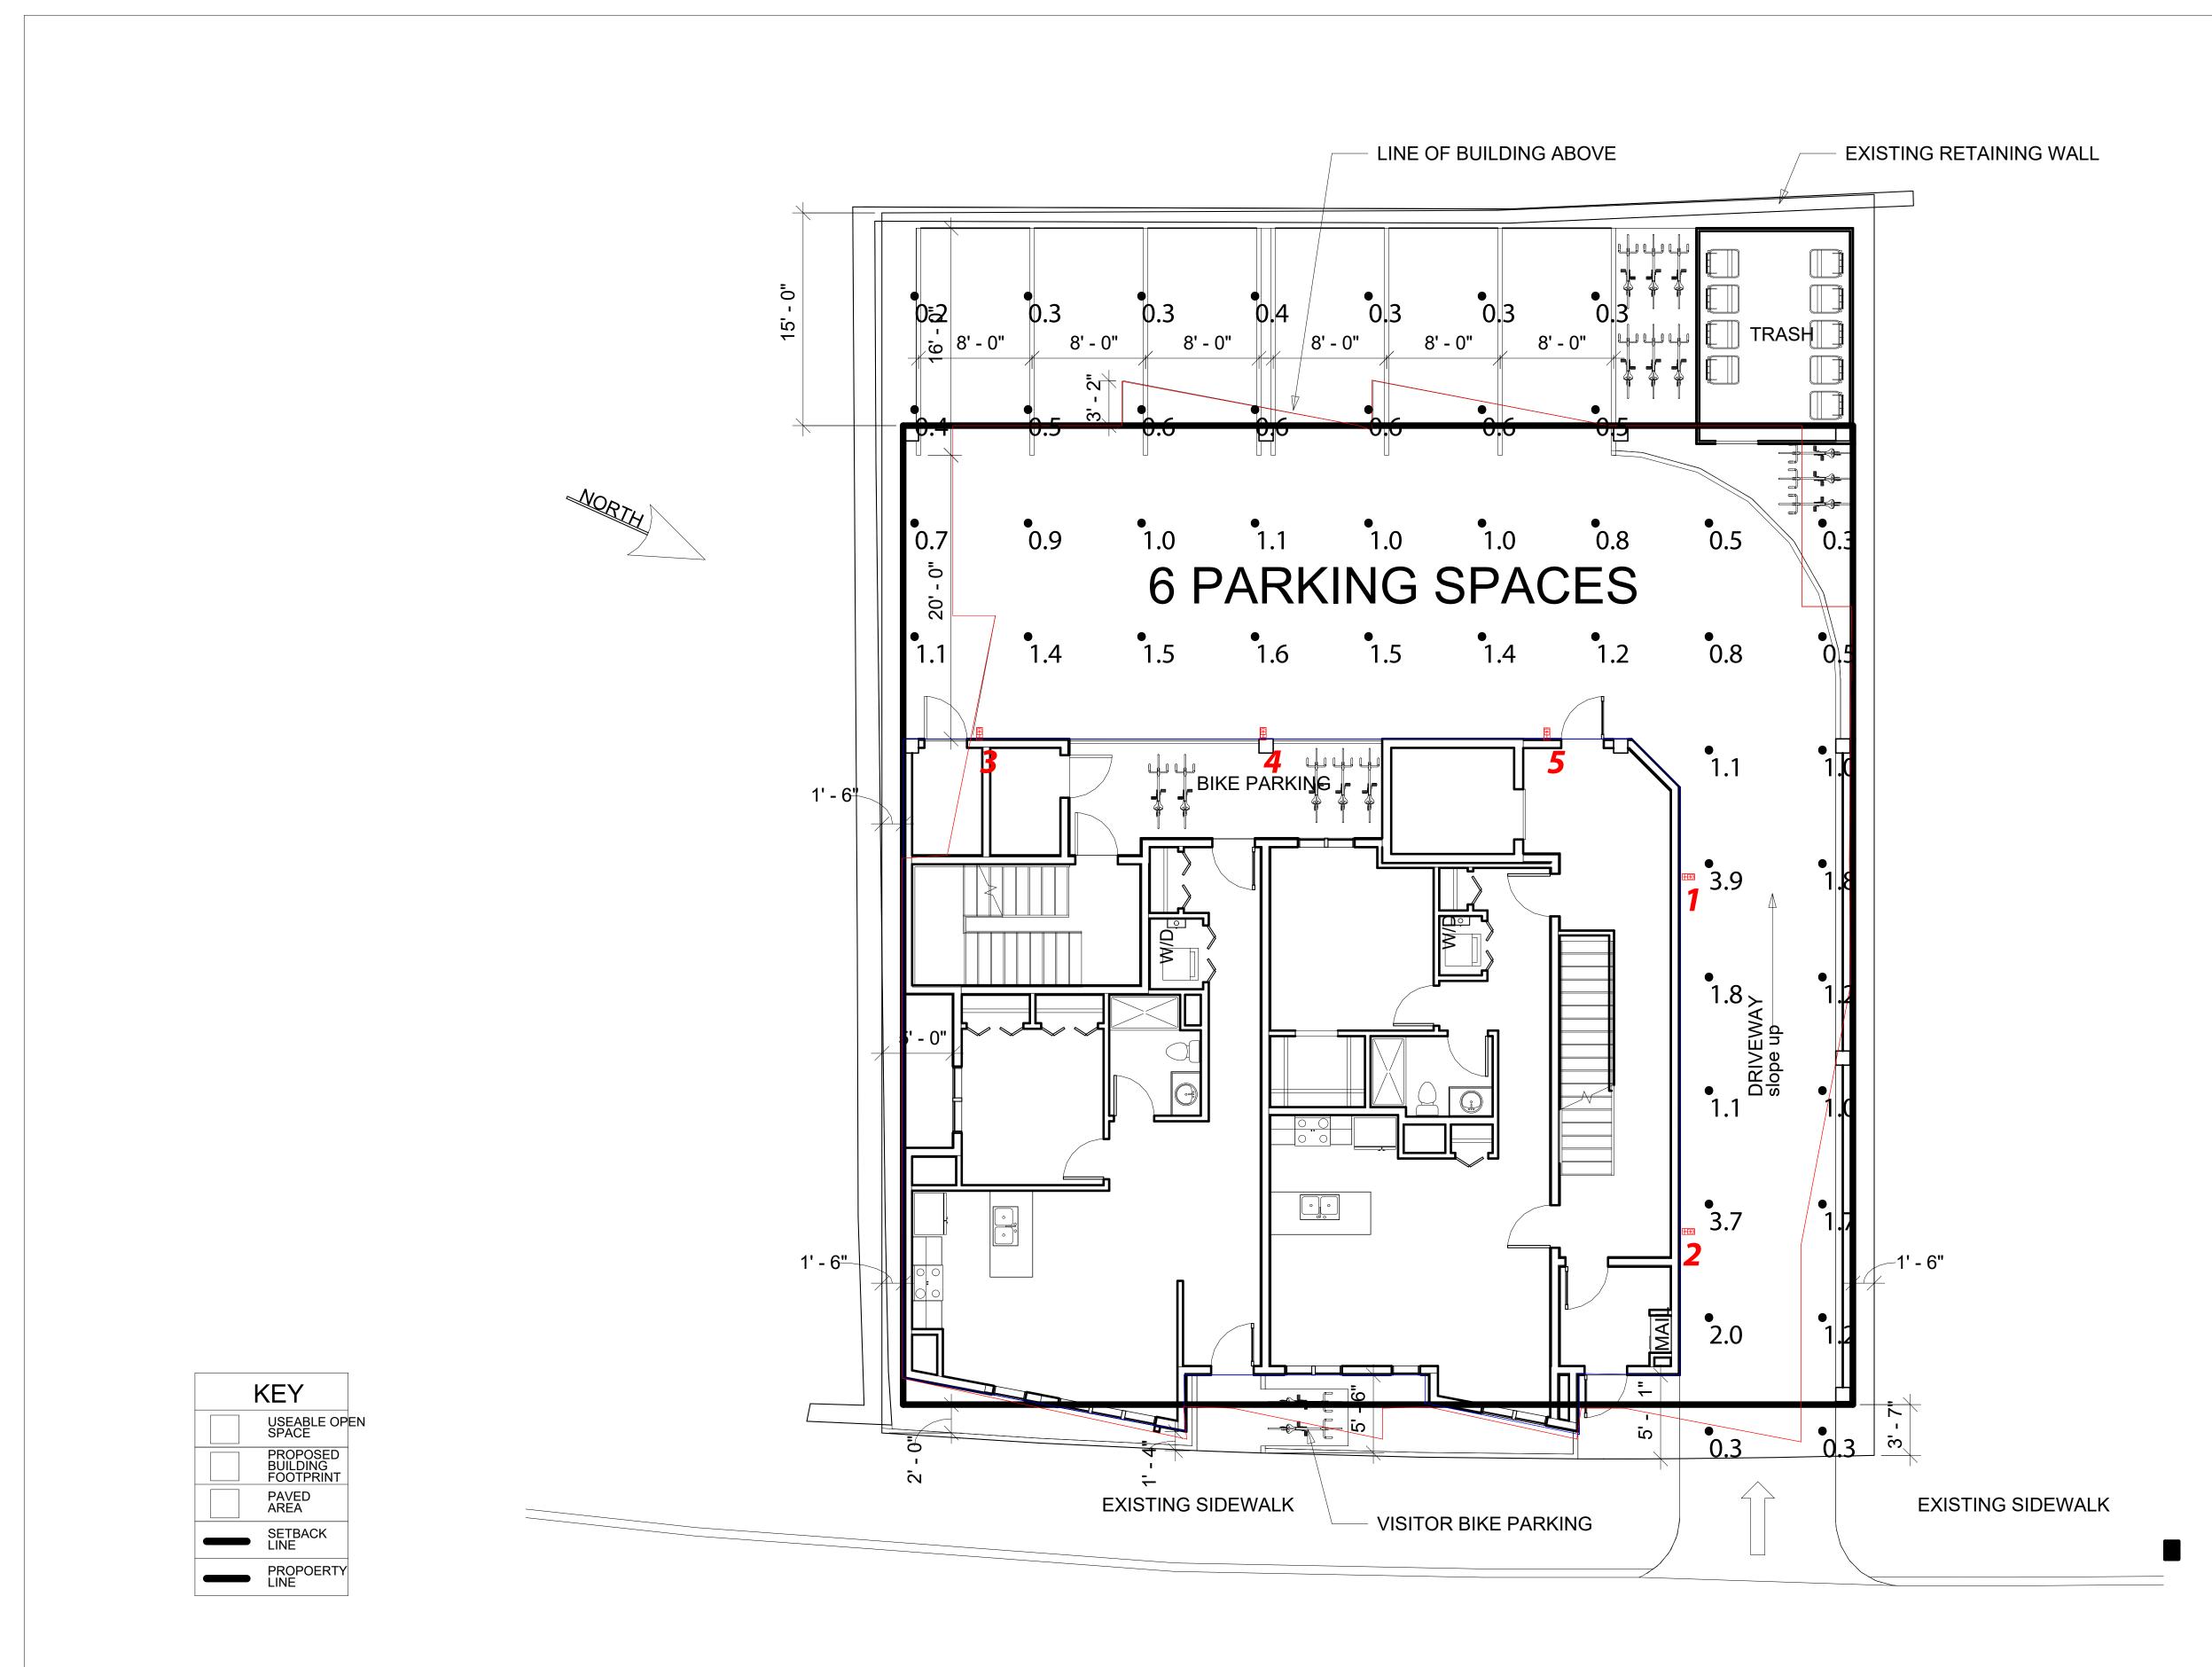






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MCGRATH HIGHWAY

RAB Lighting Inc. ("RAB") represents an anticipated prediction of lighting system performance based upon design parameters and information supplied by others. These design parameters and information provided by others han not been field verified by RAB and therefore actual measured results may vary from the actual field conditions.

RAB recommends that design parameters and other information be field verified to reduce variation.

RAB neither warranties, either implied or stated with regard to actual measured light levels or energy consumptic levels as compared to those illustrated by the Lighting Design. RAB neither warranties, either implied or stated, in represents the appropriateness, completeness or suitability of the Lighting Design intent as compliant with any applicable regulatory code requirements with the exception of those specifically stated on drawings created and

Date:3/11/2020 CASE # 341537
Filename: 394 McGrath Hwy Ltg Layout 3

Somerville, MA Lighting Layout Version A

olbrook Associated Reservoir Park Drive I: 781-871-0011

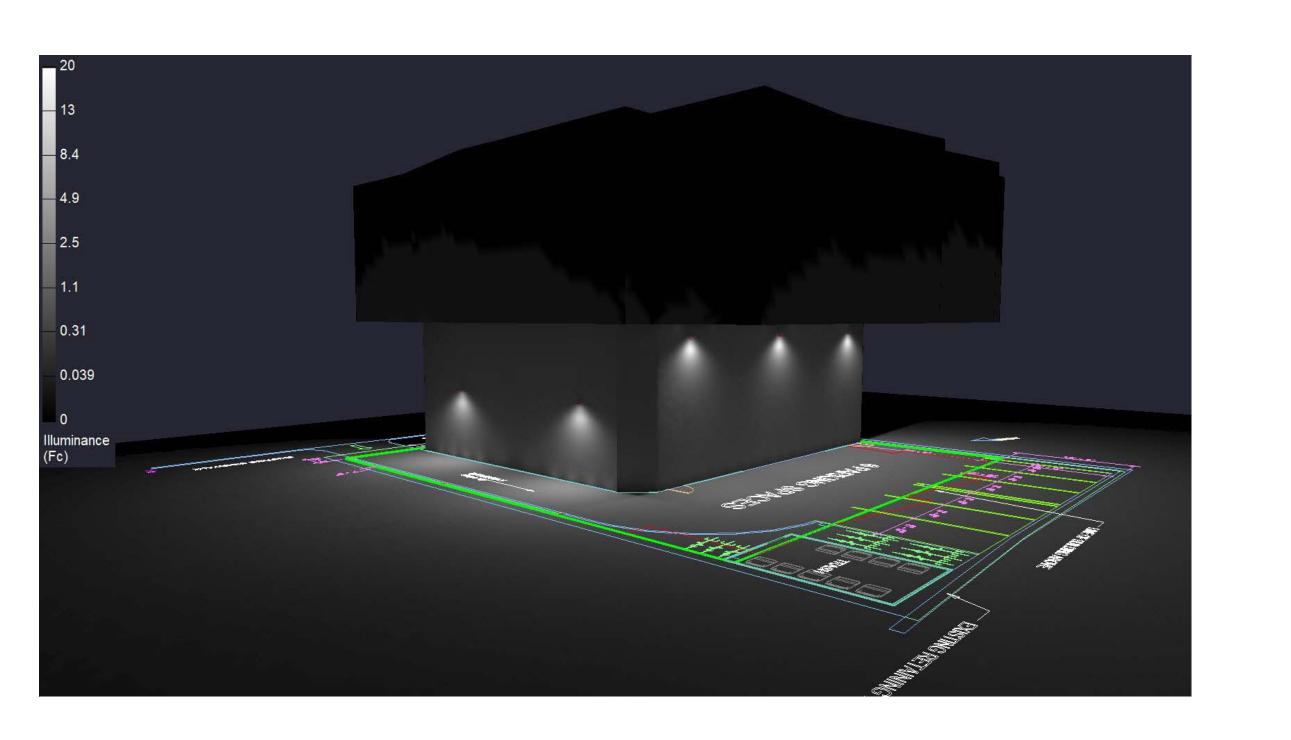
0 Ludlow Avenue, Northvale, NJ 07647

Luminaire	Sched	lule	All quotes/orders generated	from this layout must	be forw	arded to the Local Rep Agency	
Symbol	Qty	Tag	Label	Arrangement	LLF	Description	BUG Rating
	5	Α	WPLED10Y	SINGLE	1.000	Wallpack	B0-U0-G0

Calculation Summary											
Label	CalcType	Units	Avg	Max	Min	Avg/Min	Max/Min	Description	PtSpcLr	PtSpcTb	Meter Type
Parking Lot	Illuminance	Fc	1.01	3.9	0.2	5.05	19.50	Readings taken at 0'-0" AFG	8	8	Horizontal

LumNo	Tag	X	Y	MTG HT	Orient	Tilt
1	Α	113.9	55.5	10	0	0
2	Α	113.9	30.5	10	0	0
3	Α	63.788	65.727	18	90	0
4	Α	83.788	65.727	18	90	0
5	Α	103.788	65.705	18	90	0

- * The light loss factor (LLF) is a product of many variables, only lamp lumen depreciation (LLD) has been applied to the calculated results unless otherwise noted. The LLD is the result (quotient) of mean lumens / initial lumens per lamp manufacturers' specifications.
- * Illumination values shown (in footcandles) are the predicted results for planes of calculation either horizontal, vertical or inclined as designated in the calculation summary. Meter orientation is normal to the plane of calculation.
- * The calculated results of this lighting simulation represent an anticipated prediction of system performance. Actual measured results may vary from the anticipated performance and are subject to means and methods which are beyond the control of RAB Lighting Inc.
- * Mounting height determination is job site specific, our lighting simulations assume a mounting height (insertion point of the luminaire symbol) to be taken at the top of the symbol for ceiling mounted luminaires and at the bottom of the symbol for all other luminaire mounting configurations.
- * It is the Owner's responsibility to confirm the suitability of the existing or proposed poles and bases to support the proposed fixtures, based on the weight and EPA of the proposed fixtures and the owner's site soil conditions and wind zone. It is recommended that a professional engineer licensed to practice in the state the site is located be engaged to assist in this determination.
- * The landscape material shown hereon is conceptual, and is not intended to be an accurate representation of any particular plant, shrub, bush, or tree, as these materials are living objects, and subject to constant change. The conceptual objects shown are for illustrative purposes only. The actual illumination values measured in the field will vary.
- * Photometric model elements such as buildings, rooms, plants, furnishings or any architectural details which impact the dispersion of light must be detailed by the customer documents for inclusion in the RAB lighting design model. RAB is not responsible for any inaccuracies caused by incomplete information on the part of the customer, and reserves the right to use best judgement when translating customer requests into photometric studies.
- * RAB Lighting Inc. luminaire and product designs are protected under U.S. and International intellectual property laws. Patents issued or pending apply.



CASE # 341537

